# LAKE FOREST SCHOOL DISTRICT RENOVATIONS TO

# DELAWARE EARLY CHILDHOOD CENTER - HVAC UPGRADES

#### **LOCATION MAP** AREA MAP SITE MAP Shore Stop Delaware Depart West St Manor of Transpo Stone's Bar & Grill W.T. CHIPMAN WT Chipman Middle School MIDDLE SCHOOL M&T Bank Delaware Ear Childhood Cent Derby's Bar & Restaura The Chair Salon Stone's Bar & Grill V Mc Knatt Carpenter & Baker of the Living Express & Suites... GENERAL LOCATION Bridle Bit Liquors W Milby St OF PROJECT W Milby St Taylor & Messick Distribution Center Harrington, DE OI G T Midway Slots Centre Ice Arena Taylor & Messick Messick's Ag Museum Walt Messick Rd Harrington Raceway & Casino Vernon Rd

# DRAWING INDEX

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EIO-I FLOOR PLANS NEW WORK ELECTRICAL

SCHEDULES, DETAILS, LEGENDS ELECTRICAL

ARCHITECTS

RGArchitects, LLC

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302.376.8100 302.376.9851 fax

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# DING 30 JANUARY 2023

# 

Lake Forest School
District - Delaware
Early Childhood
Center - HVAC
Upgrades

100 W. Mispillion Street Harrington, Delaware 19952

# SHEET INKO:

PROJECT NO: 21046
DRAWN BY: JAR
CHECKED BY: RAG
SCALE: AS NOTED
DATE: 30 JANUARY 2023

COVER SHEET



# APPLICABLE CODES

IBC 2018 (INTERNATIONAL BUILDING CODE)
IEBC 2018 (INTERNATIONAL EXISTING BUILDING CODE)

IMC 2018 (INTERNATIONAL MECHANICAL CODE)
IECC 2018 (INTERNATIONAL ENERGY
CONSERVATION CODE)

IPC 2018 (INTERNATIONAL PLUMBING CODE)
NEC 2011 (NATIONAL ELECTRIC CODE)

#### GENERAL NOTES

- 1. THE NOTES ON THESE DRAWINGS ARE NOT INTENDED TO REPLACE SPECIFICATIONS. SEE SPECIFICATIONS FOR REQUIREMENTS IN ADDITION TO GENERAL NOTES. FOR INCONSISTENCIES BETWEEN THESE DRAWINGS AND THE SPECIFICATIONS, THE STRICTER REQUIREMENT SHALL APPLY, AND THE ENGINEER SHALL BE NOTIFIED PRIOR TO PROCEEDING WITH THE AFFECTED PORTION OF THE WORK.
- 2. STRUCTURAL DRAWINGS SHALL BE USED IN CONJUNCTION WITH JOB SPECIFICATIONS AND ARCHITECTURAL, MECHANICAL, ELECTRICAL, PLUMBING, AND SITE DRAWINGS. CONSULT THESE DRAWINGS FOR LOCATIONS AND DIMENSIONS OF OPENINGS, CHASES, INSERTS, REGLETS, SLEEVES, DEPRESSIONS, AND OTHER DETAILS NOT SHOWN ON STRUCTURAL DRAWINGS. ALL DIMENSIONS AND CONDITIONS MUST BE VERIFIED IN THE FIELD. ANY DISCREPANCIES SHALL BE BROUGHT TO THE ATTENTION OF THE ENGINEER BEFORE PROCEEDING WITH THE AFFECTED PART OF THE WORK.
- 3. THE STRUCTURE IS DESIGNED TO BE SELF SUPPORTING AND STABLE AFTER THE STRUCTURE IS COMPLETE. IT IS THE CONTRACTOR'S SOLE RESPONSIBILITY TO DETERMINE ERECTION PROCEDURES AND SEQUENCE TO INSURE THE SAFETY OF THE BUILDING AND ITS COMPONENTS DURING ERECTION. THIS INCLUDES, BUT IS NOT LIMITED TO, THE ADDITION OF NECESSARY SHORING, SHEETING, TEMPORARY BRACING, GUYS OR TIEDOWNS. PROVIDE ALL SHORING AND BRACING REQUIRED TO STABILIZE AND PROTECT EXISTING AND ADJACENT STRUCTURES AND SYSTEMS DURING COURSE OF DEMOLITION AND CONSTRUCTION. SUCH MATERIAL SHALL REMAIN THE PROPERTY OF THE CONTRACTOR AFTER COMPLETION OF THE PROJECT
- 4. SECTIONS AND DETAILS SHOWN ON ANY STRUCTURAL DRAWINGS SHALL BE CONSIDERED TYPICAL FOR SIMILAR CONDITIONS.
- 5. ALL APPLICABLE FEDERAL, STATE AND MUNICIPAL REGULATIONS SHALL BE FOLLOWED, INCLUDING THE FEDERAL DEPARTMENT OF LABOR OCCUPATIONAL SAFETY AND HEALTH ACT.
- 6. ANY AND ALL MODIFICATIONS TO THE STRUCTURAL ELEMENTS INDICATED ON THESE DRAWINGS MUST BE APPROVED IN ADVANCE BY BAKER, INGRAM & ASSOCIATES.

DESIGN LOADS


- 1.BUILDING CODE: INTERNATIONAL BUILDING CODE (2018 EDITION).
- 2.DESIGN LIVE LOADS: ROOF 30 PSF MIN. + DRIFT

#### EXISTING CONDITIONS

- 1. EXISTING CONDITIONS INDICATED ARE OBTAINED FROM AVAILABLE SOURCES (EXISTING DRAWINGS, FIELD SURVEYS, ETC.) AND ARE NOT GUARANTEED TO BE TRUE AND EXACT. CONTRACTOR(S) SHALL FIELD VERIFY EXISTING CONDITIONS AND NOTIFY THE ENGINEER OF ANY DISCREPANCIES PRIOR TO PROCEEDING WITH THE AFFECTED PORTION OF THE WORK.
- 2. SEE ARCH DRAWINGS FOR LIMITS OF DEMOLITION OF EXISTING CONSTRUCTION WHERE REQUIRED.

#### STRUCTURAL STEEL


- 1. STRUCTURAL STEEL FABRICATION, ERECTION, AND CONNECTION DESIGN SHALL CONFORM TO AISC "SPECIFICATION FOR THE DESIGN, FABRICATION, AND ERECTION OF STRUCTURAL STEEL FOR BUILDINGS" LATEST EDITION.
- 2. STRUCTURAL STEEL SHALL CONFORM TO THE FOLLOWING DESIGNATIONS: STRUCTURAL STEEL WE SHAPES: ASTM A992 OTHER STRUCTURAL STEEL SHAPES: ASTM A36, U.N.O. STEEL BARS, ANGLES & PLATES: ASTM A36, U.N.O. ROUND PIPE: ASTM A53, TYPE E OR S
- 3. ALL WELDING SHALL CONFORM TO AWS D1.1-LATEST EDITION. ELECTRODES SHALL BE ETOXX.
- 4. ALL ALUMINUM AND STEEL MEMBERS TO BE TREATED OR PROPERLY SEPARATED TO PREVENT GALVANIC AND CORROSIVE EFFECTS.
- 5. SUBMIT ALL STEEL SHOP DRAWINGS FOR APPROVAL PRIOR TO ANY FABRICATION.
- 6. CONTRACTOR IS SOLELY RESPONSIBLE FOR SURVEYING AND VERIFICATION OF EXISTING CONDITIONS INCLUDING, BUT NOT LIMITED TO THE LOCATION, ELEVATION, AND DIMENSIONS OF EXISTING WALLS AND FRAMING.
- 7. THERE SHALL BE NO FIELD CUTTING OF STRUCTURAL STEEL MEMBERS FOR THE WORK OF OTHER TRADES WITHOUT THE PRIOR APPROVAL OF THE DESIGN PROFESSIONAL.
- 8. FABRICATE BEAMS WITH THE NATURAL CAMBER UP.
- 9. ALL STEEL NOT RECEIVING FIREPROOFING SHALL BE PAINTED WITH THE FABRICATOR'S RUST INHIBITIVE PRIMER. ALL STEEL EXPOSED TO WEATHER SHALL BE PAINTED WITH RUST INHIBITIVE PRIMER AND TOP COATED OR HOT DIPPED GALVANIZED AS INDICATED ON THE DRAWINGS.

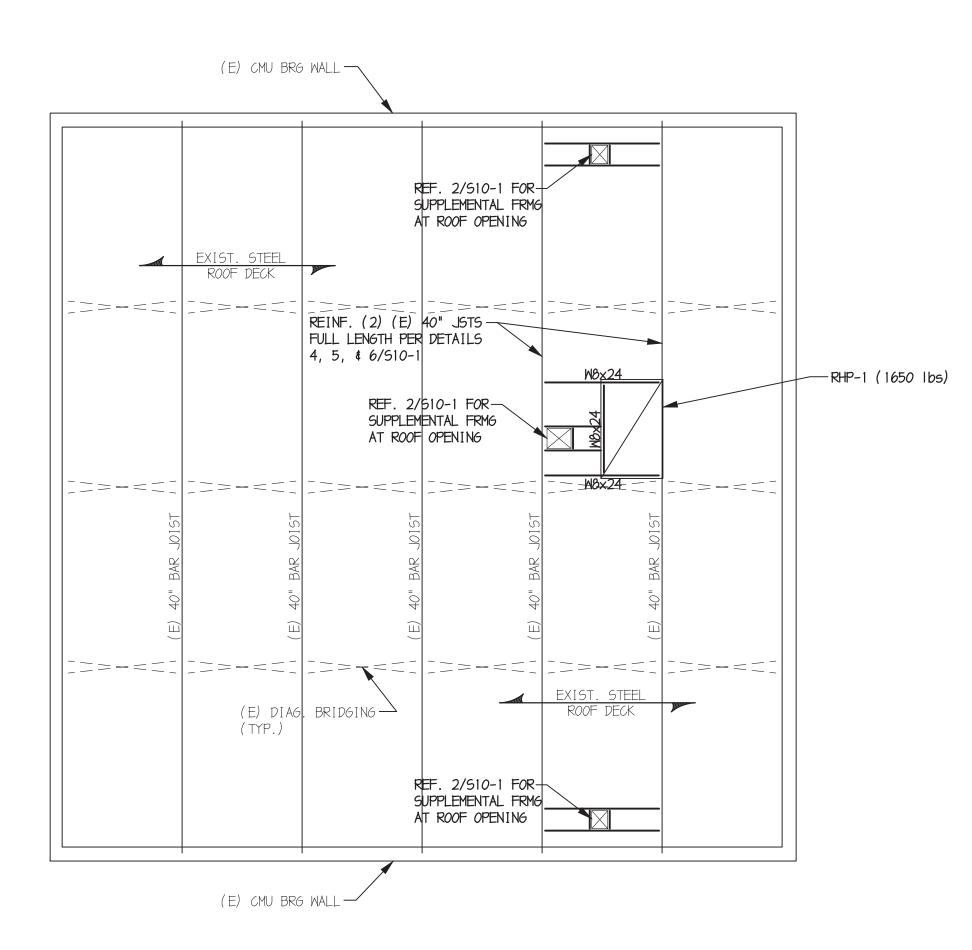





#### PARTIAL ROOF FRAMING PLAN も" = 1'-0"

- 1. COORD. DIMENSIONS & LOCATIONS W/ EXIST. CONDITIONS,
- MECH. DRAWINGS, & FINAL UNIT MANUFACTURER'S SPECS.
- 2. VERIFY EXIST. CONDITIONS IN THE FIELD PRIOR TO FABRICATION.
- 3. BEAM TO BEAM CONNECTIONS TO BE MADE USING FULL DEPTH 훓" SHEAR PLATES.

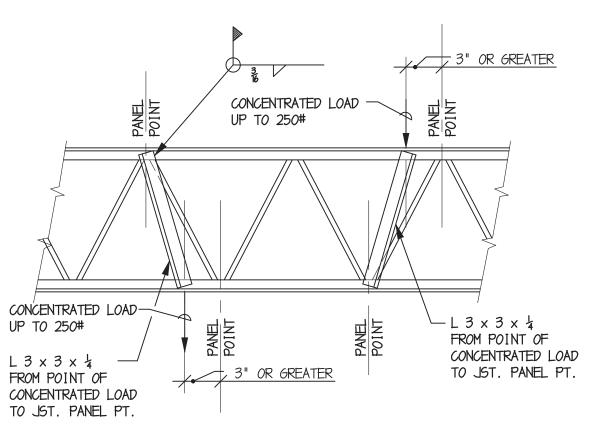


NO JOIST ANGLE REINF. REQ'D. FOR LOADS UP TO 50#.

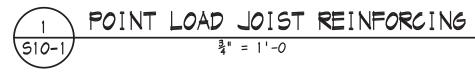


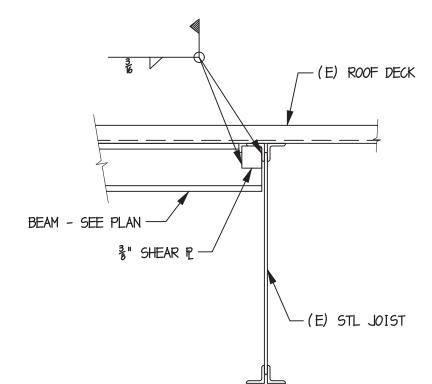

NEW BEAM - EXISTING JOIST CONNX 510-1 3 = 1'-0

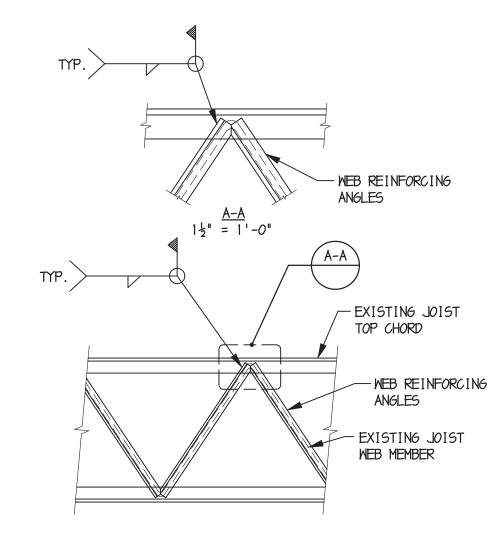


WEB REINFORCEMENT (SHEAR) (510-1) 3 = 1'-0"

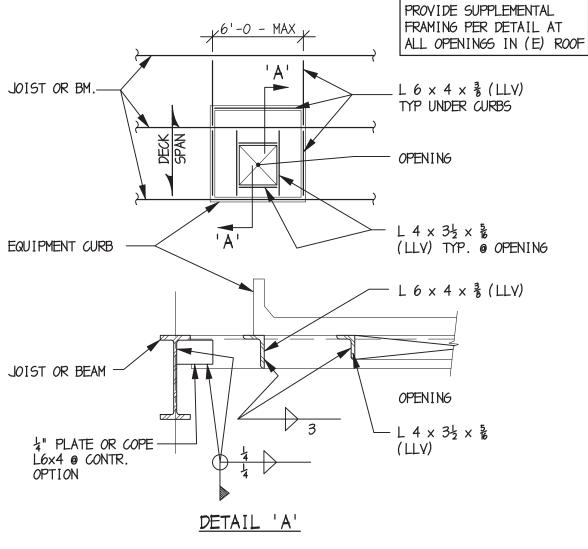

COORD SIZE & LOCATION OF CURBS & OPENINGS W/ DIVISION 15 CONTR.



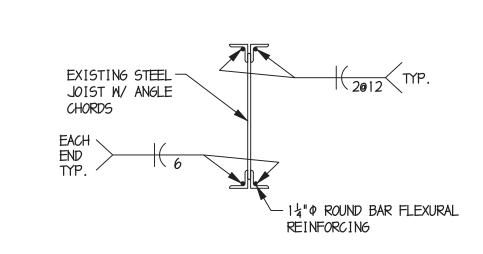

JOIST CHORD REINFORCEMENT (FLEXURE) 510-1 릴" = 1'-0"



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Project Number D14682

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**BIDDING** 

Lancaster, Pennsylvania

Haddon Heights, New Jersey Annapolis, Maryland

Dover, Delaware Newark, Delaware

ISSUED FOR

30 JANUARY 2023

PROJECT INFO:

Lake Forest School District - Delaware Early Childhood Center - HVAC Upgrades


> 100 W. Mispillion Street Harrington, DE 19952

# SHEET INFO

PROJECT NO: 21046 DRAWN BY: AJC JDM CHECKED BY: SCALE: AS NOTED 30 JANUARY 2023 DATE:

TITLE & NO.

STRUCTURAL NOTES, PARTIAL ROOF FRAMING PLAN & DETAILS

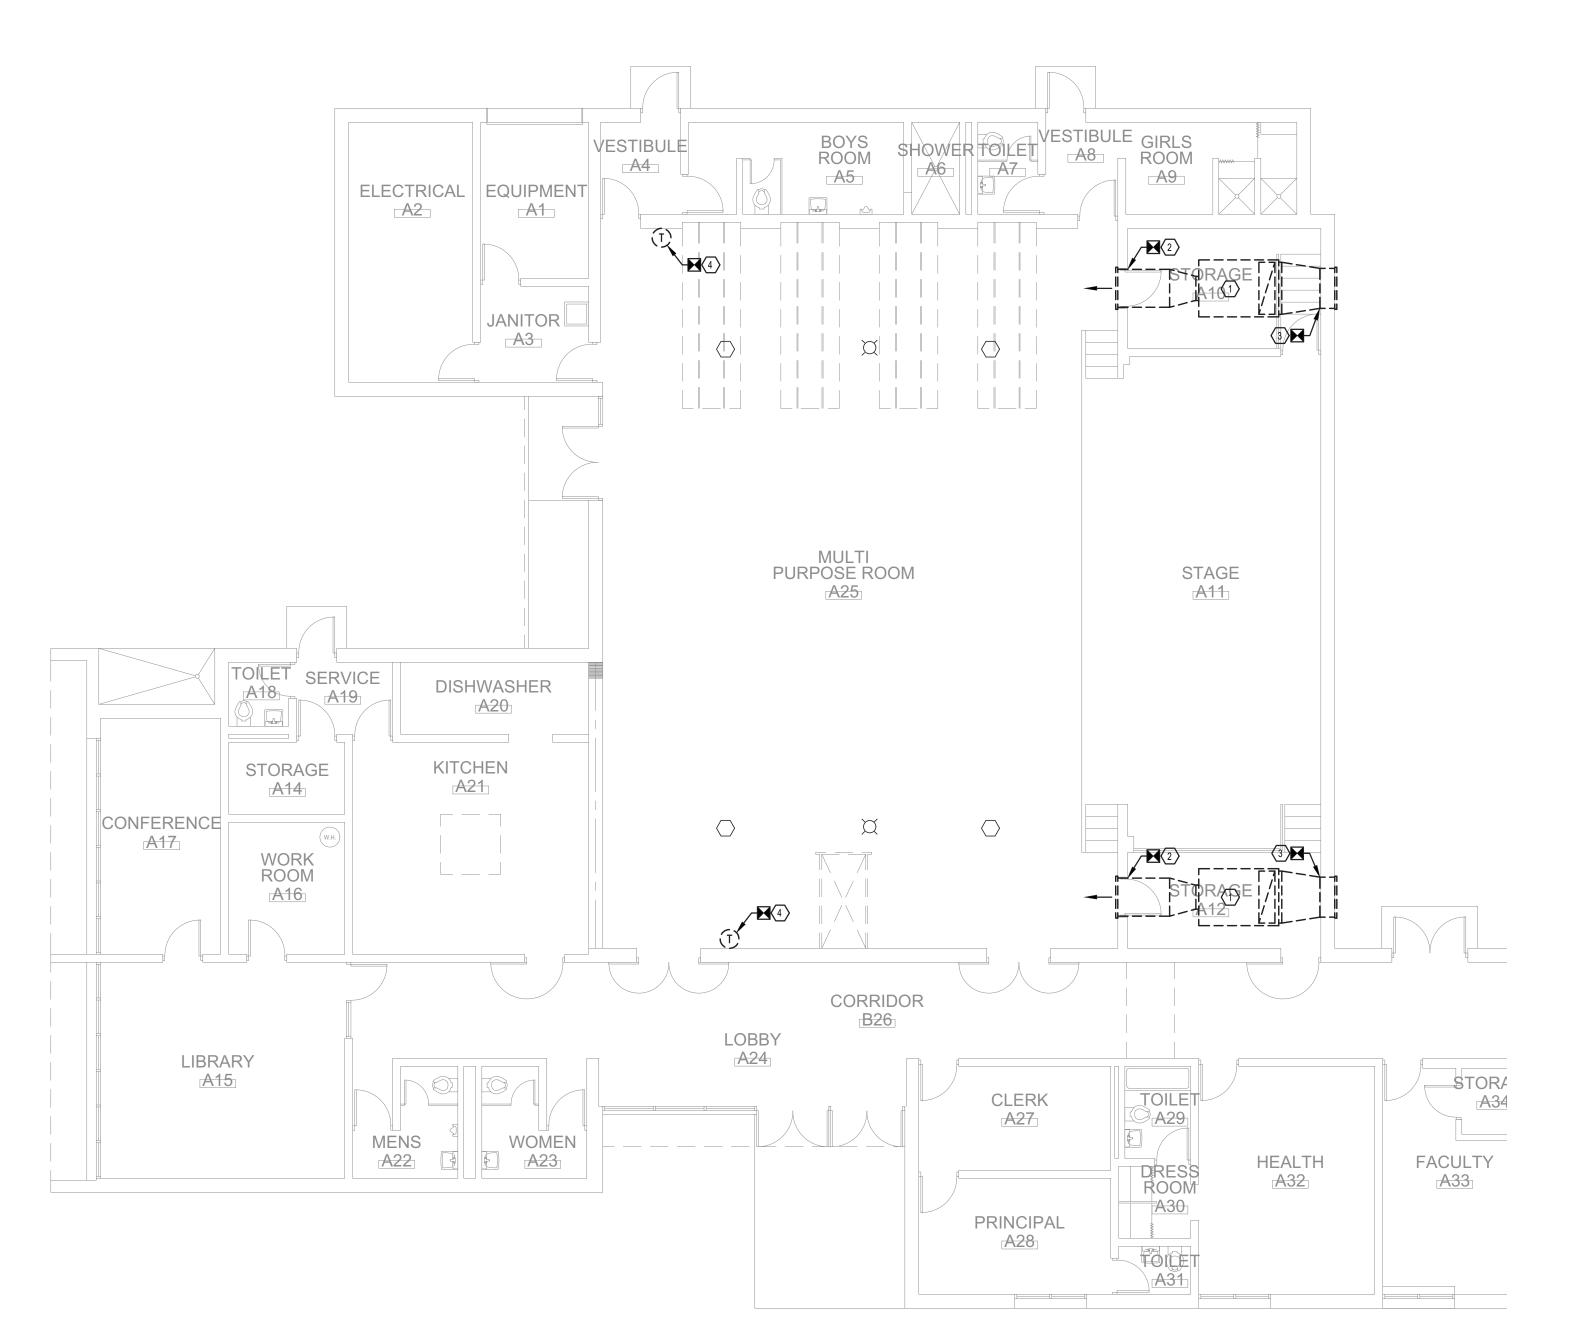

PARTIAL FLOOR PLAN - DEMOLITION - MECHANICAL

### DEMOLITION NOTES

- REMOVE H&V UNIT COMPLETELY, INCLUDING BUT NOT LIMITED TO UNIT, ELECTRIC HEATER, SUPPORTS, HANGERS, DUCTWORK, AND CONTROLS.
- REMOVE 42"x16" SUPPLY LOUVER COMPLETELY. REFER TO ARCHITECTURAL DWGS. FOR WALL
- REMOVE 42"x20" OUTSIDE AIR INTAKE LOUVER COMPLETELY. REFER TO ARCHITECTURAL DWGS. FOR WALL INFILL (BY OTHERS).
- REMOVE PNEUMATIC THERMOSTAT. CUT & CAP PNEUMATIC TUBING WITHIN WALL AND COVER WITH A METAL BLANK PLATE. FIELD VERIFY EXACT LOCATION.
- REMOVE UNIT VENTILATOR COMPLETELY, INCLUDING BUT NOT BE LIMITED TO UNIT, LOUVER, WALL SLEEVE, CONTROLS, AND CONDENSATE DRAIN.

## MECHANICAL LEGEND

POINT OF DEMOLITION BETWEEN DEMO WORK & EXISTING WORK TO REMAIN. POINT OF CONNECTION BETWEEN NEW WORK & EXISTING WORK TO REMAIN

THERMOSTAT THERMOSTAT WITH GUARD

---- EXISTING WORK/EQUIPMENT TO BE REMOVED —— — EXISTING WORK/EQUIPMENT TO REMAIN

VOLUME DAMPER CONICAL COLLAR WITH VOLUME DAMPER PIPE ELBOW DOWN

\_\_\_\_\_ NEW WORK/EQUIPMENT

PIPE ELBOW UP TRANSITION/REDUCER DSD DUCT SMOKE DETECTOR

(EX) EXISTING WORK SHALL REMAIN FC FLEX CONNECTION

> HP HEAT PUMP (R) EXISTING WORK TO BE REMOVED

RA RETURN AIR RHP ROOFTOP HEAT PUMP UNIT

RL REFRIGERANT LIQUID RS REFRIGERANT SUCTION

SA SUPPLY AIR UV UNIT VENTILATOR

# **GENERAL NOTES**

- 1. MECHANICAL CONTRACTOR SHALL PROVIDE ALL MATERIALS, LABOR, FEES AND PERMITS FOR A COMPLETE INSTALLATION. ALL WORK SHALL COMPLY WITH APPLICABLE CODES AND STANDARDS
- 2. ALL COMPONENTS REQUIRED FOR A COMPLETE INSTALLATION ARE NOT SHOWN ON THE DRAWINGS. REFER TO EQUIPMENT INSTALLATION INSTRUCTIONS FOR ADDITIONAL REQUIREMENTS, INCLUDING REQUIRED CONNECTION LOCATIONS, TYPES, & SIZES.
- 3. UNLESS SPECIFICALLY DIMENSIONED, THE WORK SHOWN ON THE DRAWINGS IS DIAGRAMMATIC ONLY TO SHOW GENERAL ARRANGEMENTS. THE DRAWINGS ARE NOT TO BE SCALED. PIPE AND DUCT ROUTING AND EQUIPMENT CONNECTION LOCATIONS SHOWN ON DRAWINGS ARE APPROXIMATE. FIELD VERIFY CLEARANCES, DIMENSIONS, MATERIALS, AND EQUIPMENT REQUIREMENTS PRIOR TO CONSTRUCTION. RELOCATE CONDUITS, PIPING HANGERS, ETC.
- 4. IT IS THE RESPONSIBILITY OF THE MECHANICAL CONTRACTOR TO PERFORM ALL WORK NECESSARY TO PREPARE STRUCTURES FOR THE INSTALLATION OF MECHANICAL SYSTEMS. ALL HOLES, OPENINGS, AND DAMAGED MATERIALS CREATED DURING CONSTRUCTION SHALL BE PATCHED AND FINISHED.
- 5. THE MECHANICAL CONTRACTOR SHALL PROVIDE ALL CUTTING, PATCHING, FINISHING, AND PENETRATIONS REQUIRED BY THE INSTALLATIONS. ALL PENETRATIONS SHALL BE PATCHED AND SEALED. CUTTING OF BUILDING CONSTRUCTION MATERIALS SHALL CONFORM TO THE CHARACTERISTICS OF THE PARTICULAR MATERIAL INVOLVED AND SHALL NOT CREATE ANY STRUCTURAL WEAKNESS OR UNSIGHTLY APPEARANCE. ALL CUTTING SHALL MEET THE APPROVAL OF THE  $\label{lem:architect} \mbox{ARCHITECT AND/OR OWNER'S REPRESENTATIVE: COORDINATE WITH THIS PARTY BEFORE COMMENCING.}$
- 6. ALL WORK, EQUIPMENT AND MATERIALS SHALL BE PROTECTED AT ALL TIMES. ALL DUCT AND PIPE OPENINGS SHALL BE PROPERLY CAPPED OR PLUGGED DURING INSTALLATION.
- 7. WHERE REQUIRED FOR CLEARANCE, TO AVOID INTERFERENCE OR EQUIPMENT CONNECTIONS, THE MECHANICAL CONTRACTOR SHALL OFFSET PIPES, DUCTS OR CONDUITS. NECESSARY SPECIAL FITTINGS OR ADAPTERS SHALL BE PROVIDED TO MAINTAIN GOOD FLOW CHARACTERISTICS. PROPERLY DRAIN AND DRIP WHERE NECESSARY.

- 8. MECHANICAL CONTRACTOR SHALL BE RESPONSIBLE FOR THE SAFETY OF HIS OWN PEOPLE. COMPLY WITH ALL OWNER'S
- 9. MECHANICAL CONTRACTOR SHALL MOUNT ALL THERMOSTATS AND ADJUSTABLE SENSORS IN FINISHED OCCUPIED
- ROOMS AT ADA HEIGHT OF 48 INCHES. 10. FOR ANY MATERIALS AND EQUIPMENT REMOVED DURING THE DEMOLITION PHASE OF THE PROJECT, THE OWNER'S
- REPRESENTATIVE SHALL APPROVE FINAL DISPOSITION OF ALL SUCH MATERIAL FOR RETENTION AND STORAGE, OR REMOVAL FROM THE SITE BY THE CONTRACTOR.

11. FOR EXISTING SYSTEMS, PROVIDE ALL HEAT TRAPS AND OR WET TAPS AS REQUIRED.

# ARCHITECTS R G Architects, LLC

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22.015 furlow associates consulting engineers 650 naamans rd, suite 211 · claymont, de 19703 www.furlowassociates.com · 302.798.3515



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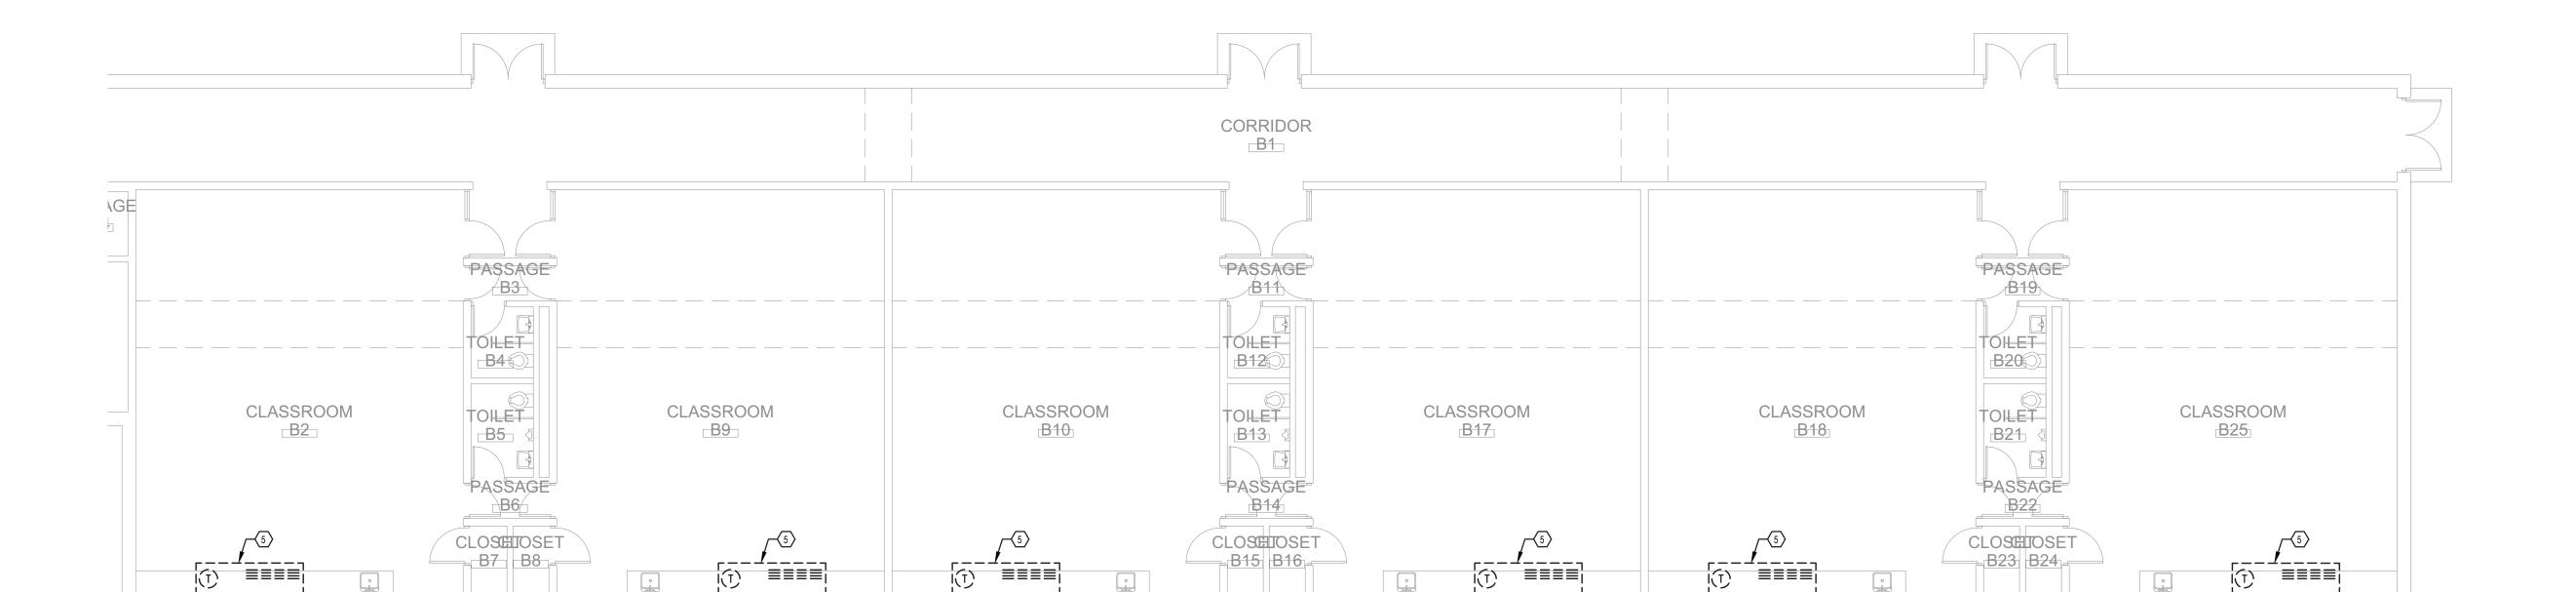
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# TITLE & NO.:


FLOOR PLANS DEMOLITION MECHANICAL




PARTIAL FLOOR PLAN - DEMOLITION - MECHANICAL SCALE : 1/8" = 1'-0"

0' 4' 8'



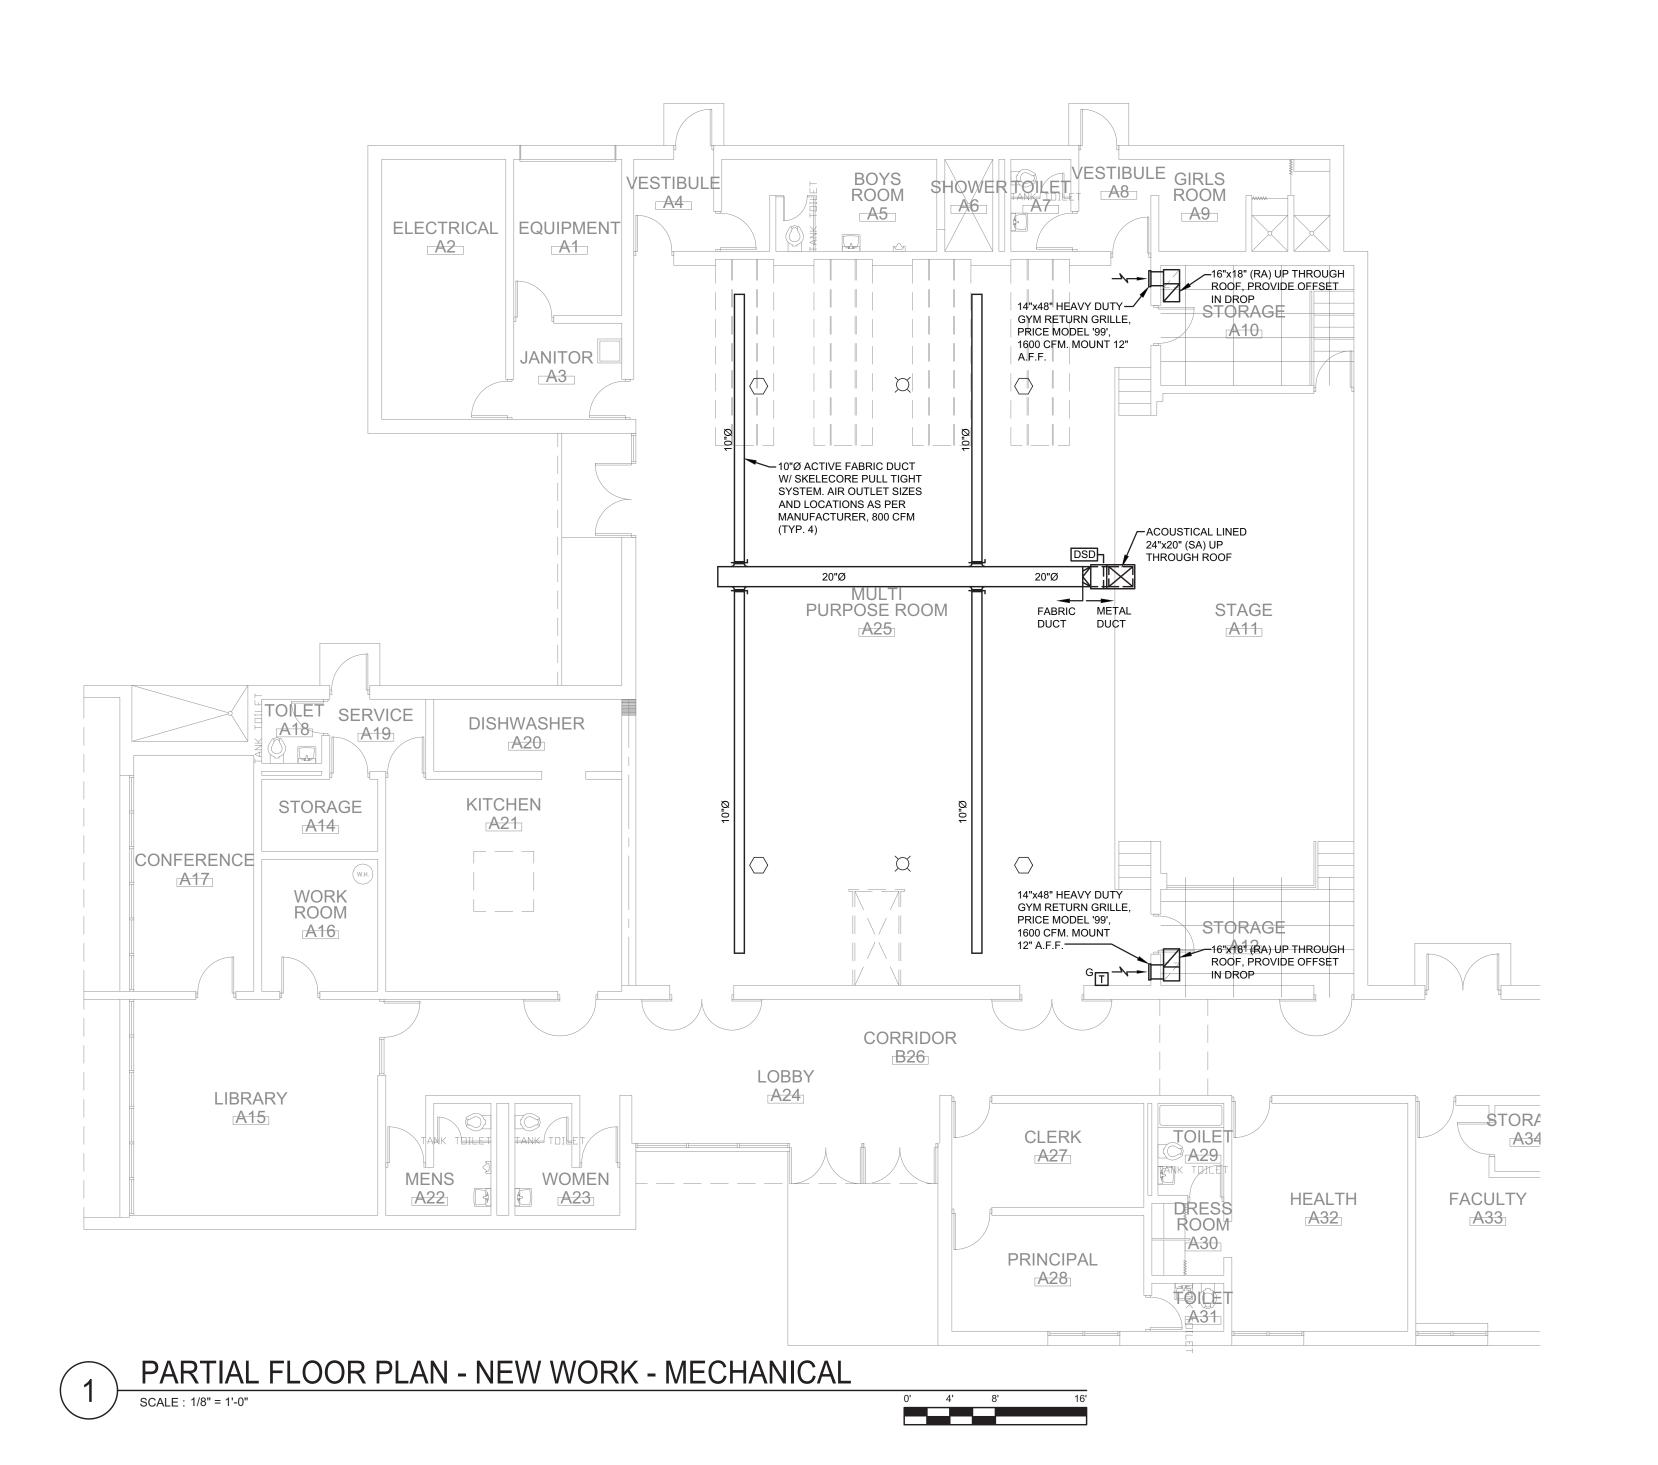

SCALE : 1/8" = 1'-0"

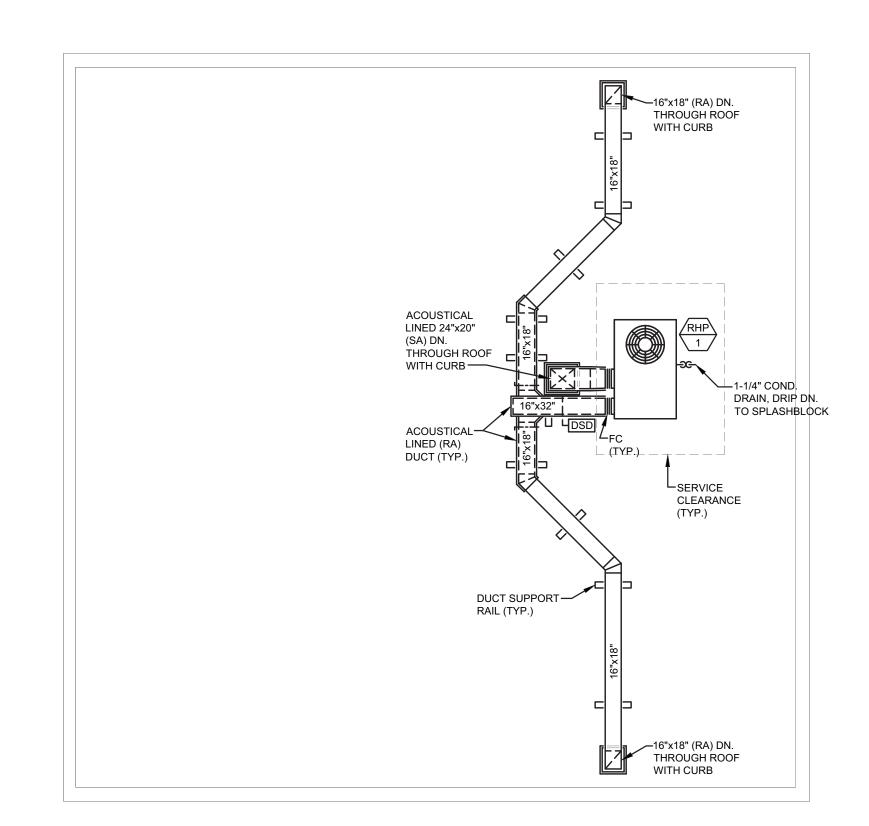

PARTIAL ROOF PLAN - NEW WORK - MECHANICAL

SCALE: 1/8" = 1'-0"



ARCHITECTS

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22.015

# PROJECT INFO:

30 JANUARY 2023

Lake Forest School
District - Delaware
Early Childhood
Center - HVAC
Upgrades


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SHE	ET INFO:
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DRAWN BY:	DEG
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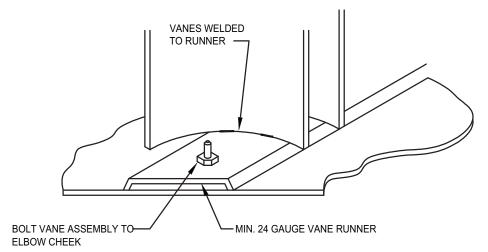
# TITLE & NO.:

FLOOR PLANS
NEW WORK
MECHANICAL






0' 4' 8'

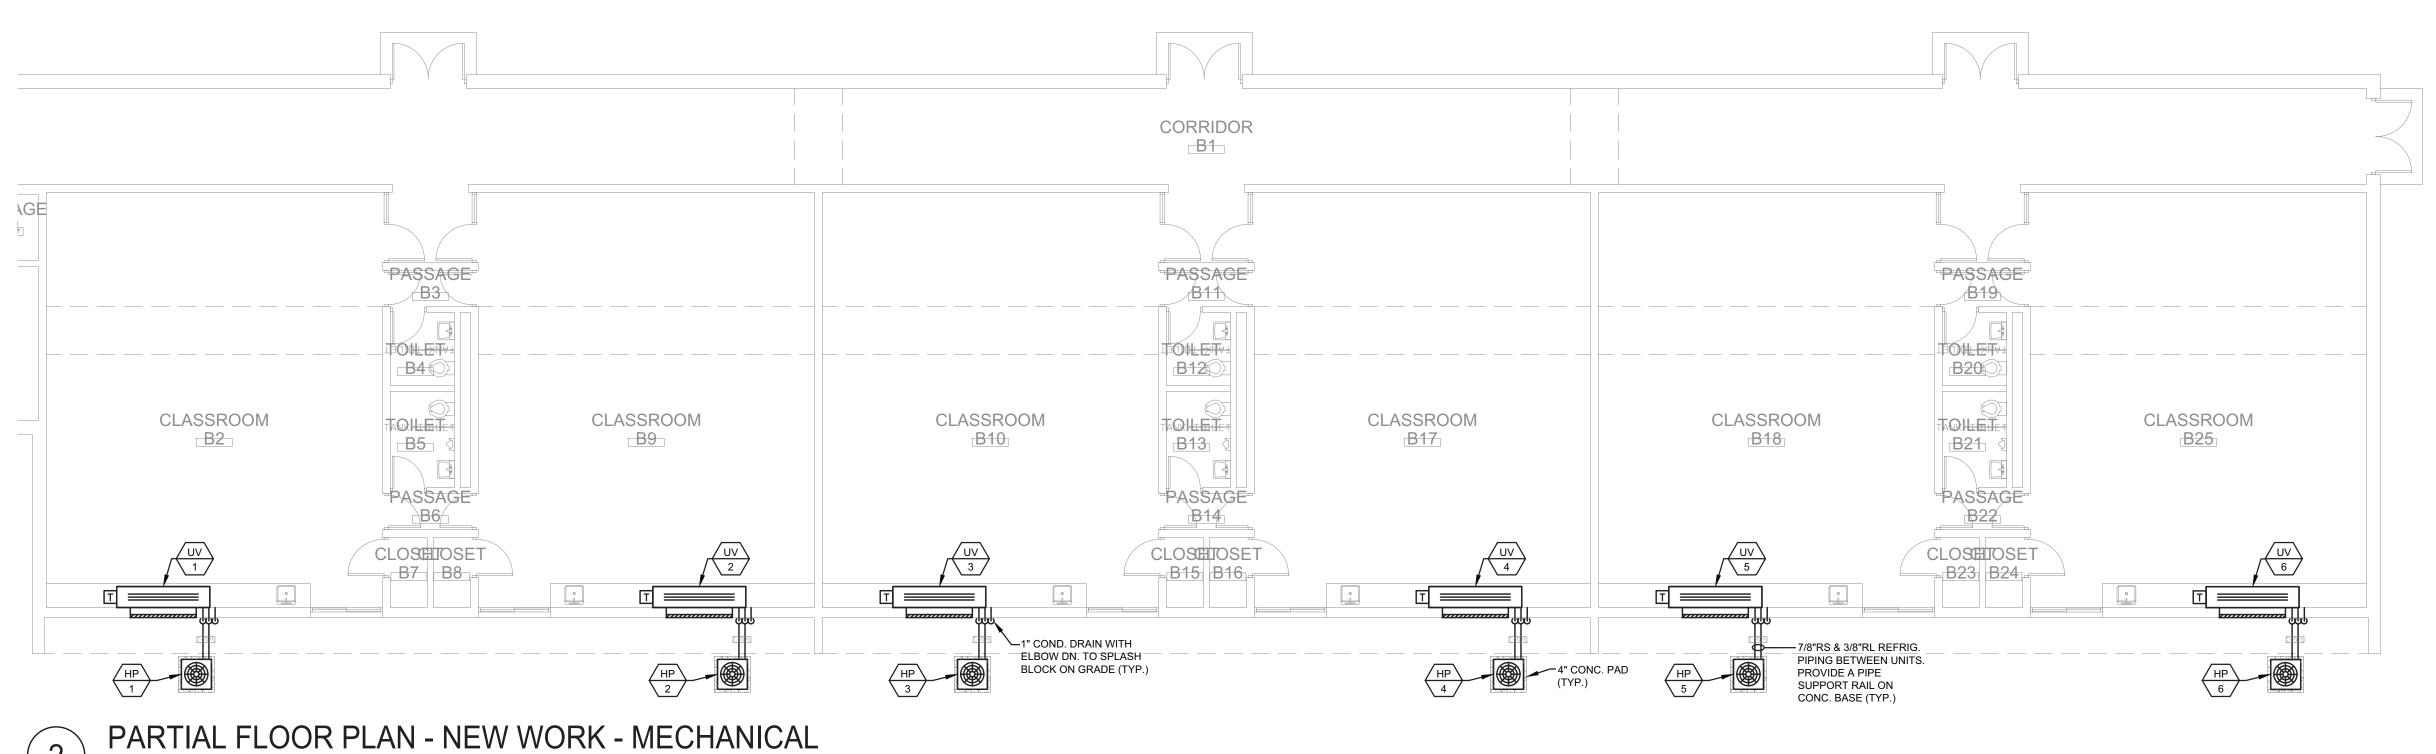


# VANE RUNNER ASSEMBLY DETAIL NOT TO SCALE

VANE RUNNER ASSEMBLY


VANE RUNNER ASSEMBLY

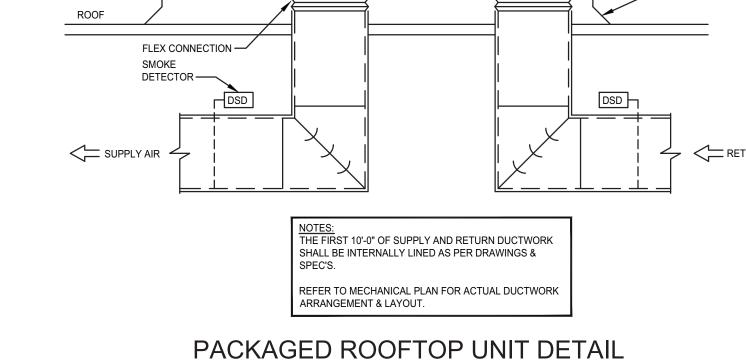

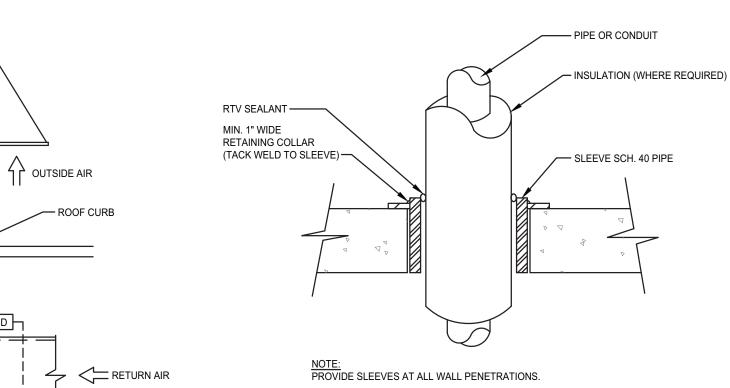

SLEEVE DETAIL

NOT TO SCALE

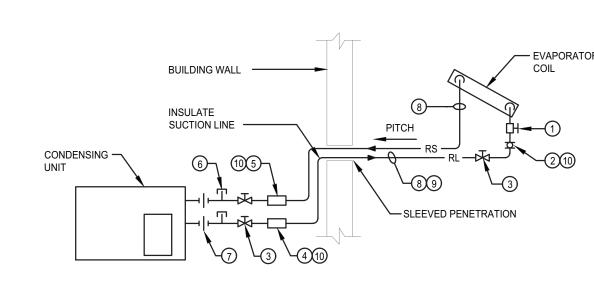

REFRIGERATION PIPING DETAIL

NOT TO SCALE

#### COMPONENTS LIST

- THERMOSTATIC EXPANSION VALVE
   MOISTURE INDICATOR/SIGHT GLASS
- 2) MOISTURE INDICATOR/SIGHT GL
- ③ DIAPHRAM PACKLESS VALVE④ FILTER DRIER (REPLACEABLE CORE)
- SUCTION LINE FILTER
   PURGE/CHARGE CONNECTION. REFRIGERANT ACCESS PORTS LOCATED OUTDOORS SHALL BE FITTED WITH
- QUICK COUPLING
- 8 LINE SIZE AS PER MANUFACTURER'S REQUIREMENT.
- (9) INSULATE LIQUID LINE IF METERING DEVICE IS MOUNTED IN CONDENSING UNIT.
- (10) COORDINATE INLINE DEVICES WITH THE SYSTEM MANUFACTURER'S INSTALLATION INSTRUCTIONS. DELETE THESE ITEMS IF SO INDICATED BY THE MANUFACTURER.

LOCKING-TYPE TAMPER RESISTANCE CAPS OR SHALL BE OTHERWISE SECURED TO PREVENT UNAUTHORIZED

NOTE:
CONFIRM WITH MANUFACTURER ALL COMPONENTS BEING
PROVIDED WITH SYSTEM. IF NOT PROVIDED BY
MANUFACTURER, CONTRACTOR SHALL BE RESPONSIBLE
TO PROVIDE.

22.015

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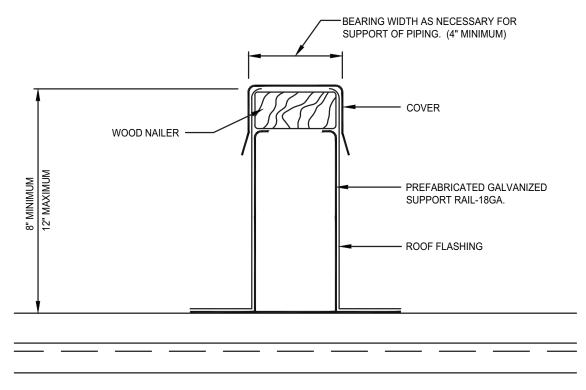
# VANED ELBOW DETAIL

NOT TO SCALE

NOT TO SCALE

3. UNIT SHALL BE 21 1/4" DEEP.

4. FINAL COLOR SELECTION BY ARCHITECT/OWNER.



NOTE:
FOR PIPING RAILS: PROVIDE SADDLES, PIPE ROLLERS, CLAMPS, ETC. & SECURE TO RAIL.

ROOF DUCTWORK / PIPING SUPPORT RAIL DETAIL

#### DRAIN LINE SHALL BE AT LEAST THE SAME SIZE AS THE NIPPLE ON THE DRAIN PAN, NO LESS THAN 1" PIPE. — CLEAN OUT -—COOLING COIL PITCH DOWN TOWARD DRAIN— - DRAIN PAN CLEAN OUT-■ ELEVATION AS REQUIRED TO SUIT DRAIN TRAP DIMENSIONS. - SPLASH BLOCK ON ROOF/GRADE. UNIT TYPE A B DRAW THRU 1 + 'X' A/2 BLOW THRU 1" MIN. 0.5 + X WHERE X = FAN TOTAL STATIC PRESSURE NOTE: ALL PIPING ON INTERIOR UNITS SHALL BE INSULATED.

## CONDENSATE DRAIN TRAP DETAIL

NOT TO SCALE

ROOFTOP HEAT PUMP UNIT SCHEDULE																											
	FOLUDATALT CA OA ESP							COOLING (R-410A)						HEATING @ 47° AUX. ELECTRIC		AUX. ELECTRIC HEAT		ELECTRIC DATA									
EQUIPMENT L' NUMBER	LOCATION	SA CFM	CFM (1)	ESP (IN. W.C.)	TSP (IN. W.C.)	HP	RPM	TOTAL	SENS	EAT	(°F)	LAT (°F)		EER	MBH	EAT (°F)	LAT (°F)	F) KW @ 460 VOLT / 3 PH.	VOLT/ PHASE	MCA	MOCP	FACTORY	FACTORY	SPP	MAKE & MODEL	WEIGHT (LBS)	NOTES
			(.,					MBH	MBH	Db	Wb	Db	Wb									STARTER	DISCONNECT	5			
RHP-1	ROOF	3200	500	1.0	1.6	2.75	1381	115	85	78	65	55	54	11.5	115	59	91	27	460/3	64	70	NO	NO	YES	TRANE MODEL 'WHC120'	1617	2
NOTES:	VIIAC DEEN DE		N 4000 CE	M TO 500 CF	- N.A. NA/UTLI I TLI		THE DLACMA	AIDE DUDU	FICATION C	VOTEM					l			1	1	1	<u> </u>	1	<u> </u>	<u> </u>			<u> </u>
	OA QUANTITY HAS BEEN REDUCED FROM 1000 CFM TO 500 CFM WITH THE USE OF THE PLASMA-AIRE PURIFICATION SYSTEM.  RHP-1 SHALL BE PROVIDED WITH ROOF CURB, ECONOMIZER, MERV 13 FILTERS, POWERED EXHAUST, PHASE MONITOR, AND PROGRAMMABLE ZONE TEMPERATURE SENSOR.																										

SYSTEM	ORIGINAL	REDUCED	ELECT	TRICAL	MIN. ION DENSITY	MAKE & MODEL	NOTES
SYSTEM	OA CFM	OA CFM	VOLT WATTS		(IONS/CC)	MAKE & MODEL	NOTES
RHP-1	1000	500	24	2.2	60M IONS/CC PER 0.5 INCH OF BAR	PLASMA AIR INT. MODEL 'PB-018'	1,2
UV-1	325	125	24	1	800-1500 IONS/CC	PLASMA AIR INT. MODEL '600'	1
UV-2	325	125	24 1 8		800-1500 IONS/CC	PLASMA AIR INT. MODEL '600'	1
UV-3	325	125	24	1	800-1500 IONS/CC	PLASMA AIR INT. MODEL '600'	1
UV-4	325	125	24	1	800-1500 IONS/CC	PLASMA AIR INT. MODEL '600'	1
UV-5	325	125	24	1	800-1500 IONS/CC	PLASMA AIR INT. MODEL '600'	1
UV-6	325	125	24	1	800-1500 IONS/CC	PLASMA AIR INT. MODEL '600'	1

UV PLAN N SYMBO	UV PLAN SYMBOL UNIT VENTILATOR SCHEDULE																						
			FAN	I DATA			COC	DLING (R-	410A)			AUX	(. ELECTF	RIC HEAT	ER			E	LECTRIC DAT	·A			
EQUIPMENT NUMBER	AREA SERVED	SA	OA CFM	SPEED	HP	TOTAL	SENS.	EAT	(°F)	LAT	(°F)	TOTAL	KW	EAT	LAT	VOLT/	MCA	МОСР	FACTORY	FACTORY	SPP	MAKE & MODEL	NOTES
		CFM	(1)	SPEED	HP	MBH	MBH	Db	Wb	Db	Wb	MBH	KVV	(°F)	(°F)	PHASE	MCA	MOCP	STARTER	DISCONNECT	5PP		
UV-1	CLASSROOM	1250	125	HIGH	1/4	33	24	77	65	56	55	33.3	9.75	65	90	460/3	18.6	20	NO	YES	YES	TRANE MODEL 'VUVE1254'	1,2,3,4
UV-2	CLASSROOM	1250	125	HIGH	1/4	33	24	77	65	56	55	33.3	9.75	65	90	460/3	18.6	20	NO	YES	YES	TRANE MODEL 'VUVE1254'	1,2,3,4
UV-3	CLASSROOM	1250	125	HIGH	1/4	33	24	77	65	56	55	33.3	9.75	65	90	460/3	18.6	20	NO	YES	YES	TRANE MODEL 'VUVE1254'	1,2,3,4
UV-4	CLASSROOM	1250	125	HIGH	1/4	33	24	77	65	56	55	33.3	9.75	65	90	460/3	18.6	20	NO	YES	YES	TRANE MODEL 'VUVE1254'	1,2,3,4
UV-5	CLASSROOM	1250	125	HIGH	1/4	33	24	77	65	56	55	33.3	9.75	65	90	460/3	18.6	20	NO	YES	YES	TRANE MODEL 'VUVE1254'	1,2,3,4
UV-6	CLASSROOM	1250	125	HIGH	1/4	33	24	77	65	56	55	33.3	9.75	65	90	460/3	18.6	20	NO	YES	YES	TRANE MODEL 'VUVE1254'	1,2,3,4
1	SE:  QUANTITY HAS BEEN REDUCED FROM 325 CFM TO 125 CFM WITH THE USE OF THE PLASMA-AIRE PURIFICATION SYSTEM. REFER TO SEPARATE SCHEDULE.  OVIDE VERTICAL UNIT WITH ECM MOTOR, END PANELS, MERV 13 FILTER, ELECTRIC HEATER, WALL BOX WITH LOUVER, FLANGE & GRILLE, CSTI CONTROLLER, TOGGLE DISCONNECT SWITCH, AND STAND ALONE BUILT-IN CONTROLS WITH TIME CLOCK.																						

EQUIPMENT	SYSTEM		RESSOR TOR	CONDENSER FAN MOTOR				ELECTRI		VOLT/	MBH	MEDIUM	CONDENSER E.A.T.	550	MAKE & MODEL	NOTES	
NUMBER	SERVED	QTY.	RLA	QTY.	HP	FLA	MCA	FACTORY STARTER	FACTORY DISCONNECT	SPP	PHASE	MBH	WILDIOW	DB(°F)	EER	MAKE & MODEL	NOTES
HP-1	UV-1	1	4.3	1	1/8	0.4	6	NO	NO	YES	460/3	36	R-410A	95	11.5	TRANE MODEL '4TWA4036A'	-
HP-2	UV-2	1	4.3	1	1/8	0.4	6	NO	NO	YES	460/3	36	R-410A	95	11.5	TRANE MODEL '4TWA4036A'	-
HP-3	UV-3	1	4.3	1	1/8	0.4	6	NO	NO	YES	460/3	36	R-410A	95	11.5	TRANE MODEL '4TWA4036A'	-
HP-4	UV-4	1	4.3	1	1/8	0.4	6	NO	NO	YES	460/3	36	R-410A	95	11.5	TRANE MODEL '4TWA4036A'	-
HP-5	UV-5	1	4.3	1	1/8	0.4	6	NO	NO	YES	460/3	36	R-410A	95	11.5	TRANE MODEL '4TWA4036A'	-
HP-6	UV-6	1	4.3	1	1/8	0.4	6	NO	NO	YES	460/3	36	R-410A	95	11.5	TRANE MODEL '4TWA4036A'	-

2. POWER SUPPLY SHALL HAVE PLASMA "ON" INDICATION LIGHT.

BIDDING 30 JANUARY 2023

# PROJECT INFO:

Lake Forest School
District - Delaware
Early Childhood
Center - HVAC
Upgrades


100 W. Mispillion Street Harrington, Delaware 19952

SHE	ET INFO:
PROJECT NO:	21046
DRAWN BY:	DEG
CHECKED BY:	SAJ
SCALE:	AS NOTED
DATE:	30 JANUARY 2023

# TITLE & NO

SCHEDULES &
DETAIL



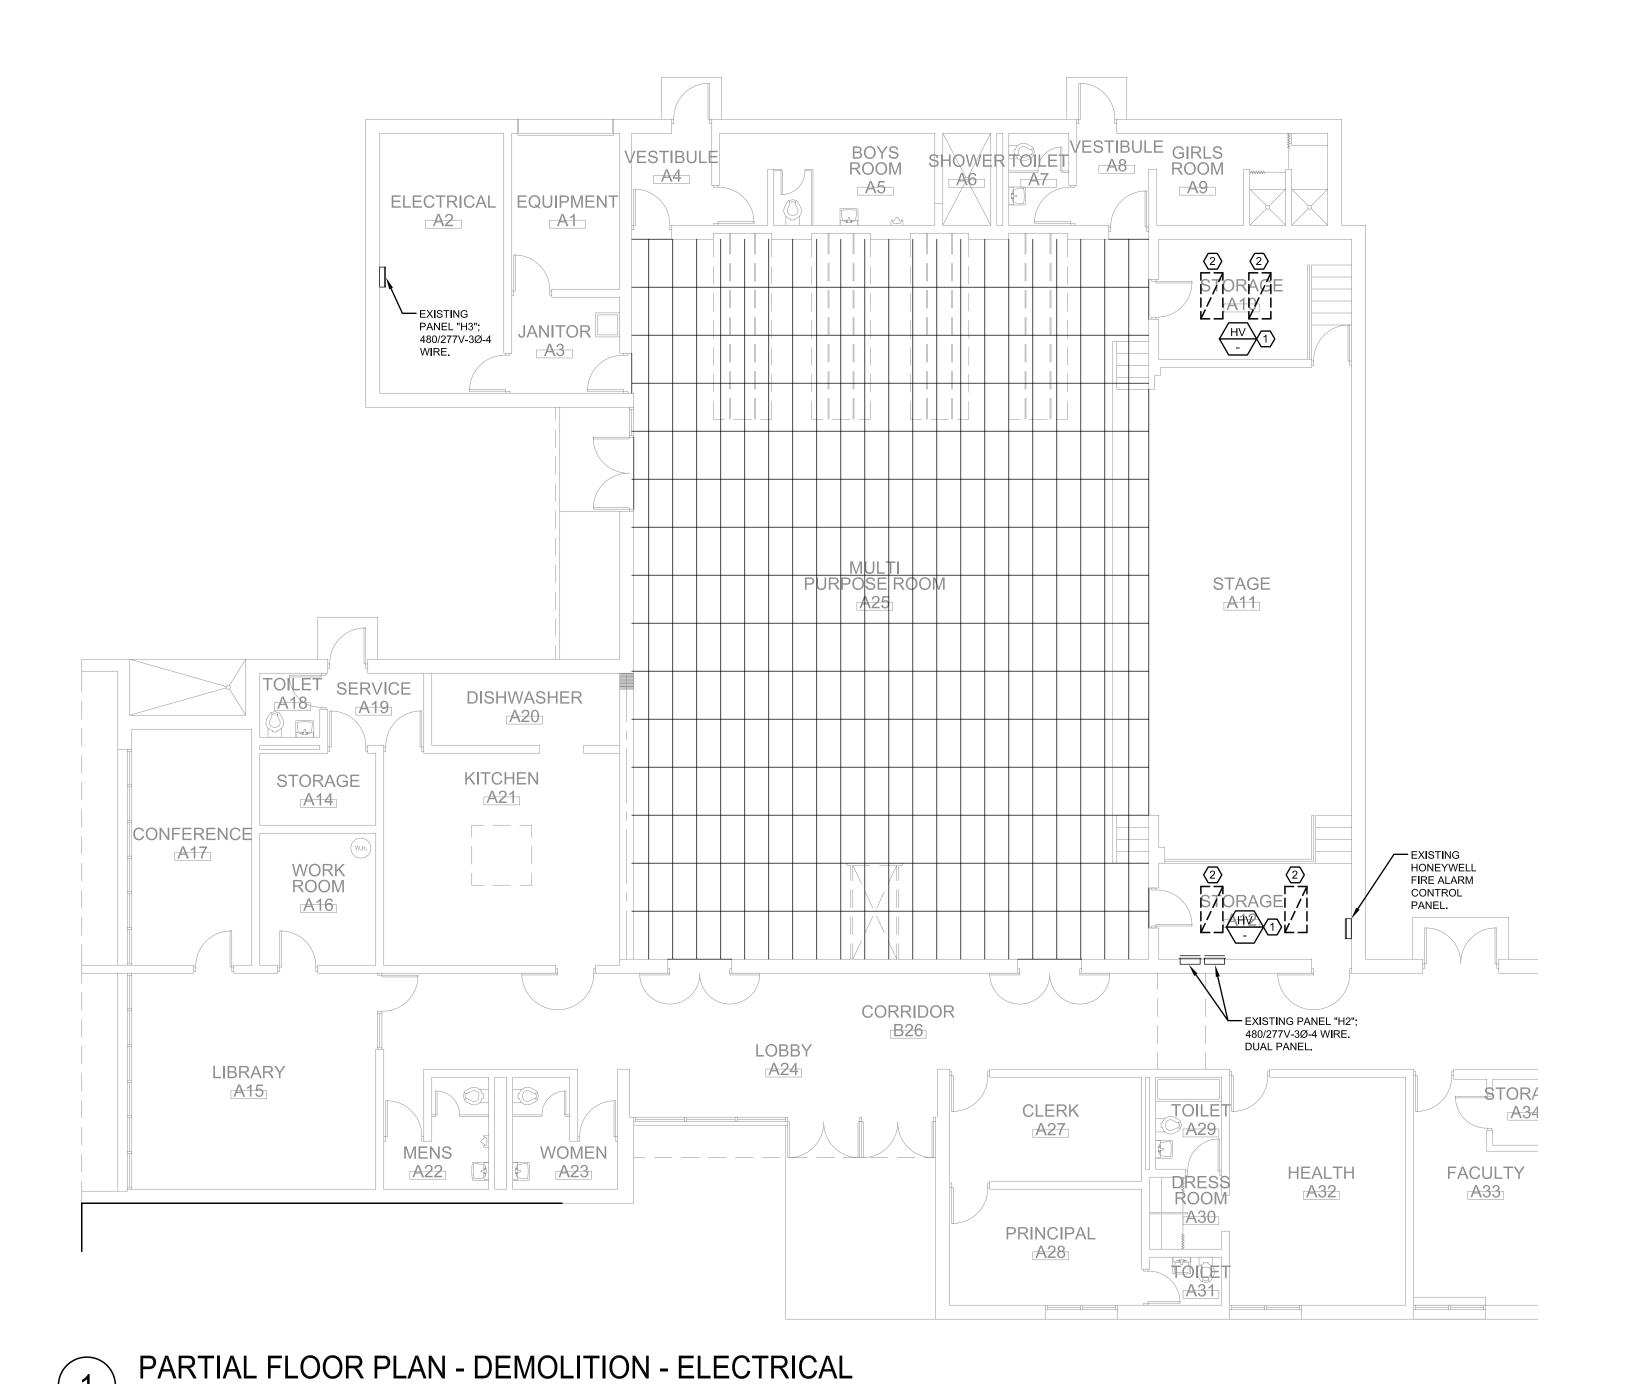

## DEMOLITION NOTES

- DISCONNECT AND REMOVE FEED COMPLETE TO SOURCE. CIRCUIT BREAKERS TO BE REMOVED AND TURNED OVER TO OWNER.
- DISCONNECT AND SAFE OFF CIRCUIT TO EXISTING LIGHT FIXTURE. REMOVE FIXTURE COMPLETE. REFER TO NEW WORK PLANS FOR ADDITIONAL WORK. SWITCH CONTROL AND CIRCUIT TO REMAIN AND BE REUSED.
- DISCONNECT AND SAFE OFF CIRCUIT TO UNIT. UPON COMPLETION OF INSTALLATION OF NEW UNIT RECONNECT BACK TO EXISTING CIRCUIT.

### DEMO LEGEND

2 X 4 RECESSED TROFFER

cs 65

ELECTRIC PANELBOARD SURFACE/FLUSH MOUNTED

# GENERAL NOTES

ARCHITECTURAL DRAWINGS. FOR ALL LOCATIONS.

PROJECT THAT IS NOT UL LISTED.

- 1. ALL ELECTRICAL WORK TO BE DONE IN ACCORDANCE WITH THE NATIONAL ELECTRICAL CODE AND LOCAL CODES WHERE APPLICABLE.
- 2. REFER TO PROJECT SPECIFICATIONS WHICH ACCOMPANY THESE DRAWINGS AND ARE PART OF THE CONTRACT.
- 3. ELECTRICAL CONTRACTOR SHALL BE RESPONSIBLE FOR VERIFYING ALL FIELD CONDITIONS BEFORE STARTING PROJECT.
- 4. ELECTRICAL CONTRACTOR TO BE RESPONSIBLE FOR ALL FINAL CONNECTIONS TO ALL EQUIPMENT.
- 5. ELECTRICAL CONTRACTOR SHALL SEAL ALL WALL / FLOOR PENETRATIONS AND COMPARTMENTALIZATION WALLS WITH A UL APPROVED FIRE STOP. REFER TO
- 6. DRAWINGS AREA DIAGRAMMATIC AND INDICATE GENERAL ARRANGEMENT OF SYSTEMS AND WORK INCLUDED.
- 7. THERE SHALL BE NO ELECTRICAL SYSTEMS OR HARDWARE INSTALLED ON THIS
- 8. ALL BRANCH CIRCUITING INSTALLED IN UNFINISHED AREAS SUCH AS MECHANICAL SPACES WILL REQUIRE THAT THESE CIRCUITS BE INSTALLED IN EMT CONDUIT. NM, AC OR MC CABLE WILL NOT BE ACCEPTED.



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DDING 30 JANUARY 2023

# PROJECT INTO:

Lake Forest School
District - Delaware
Early Childhood
Center - HVAC
Upgrades


100 W. Mispillion Street Harrington, Delaware 19952

# PROJECT NO: 21046 DRAWN BY: DMG CHECKED BY: SAJ


CHECKED BY: SAJ
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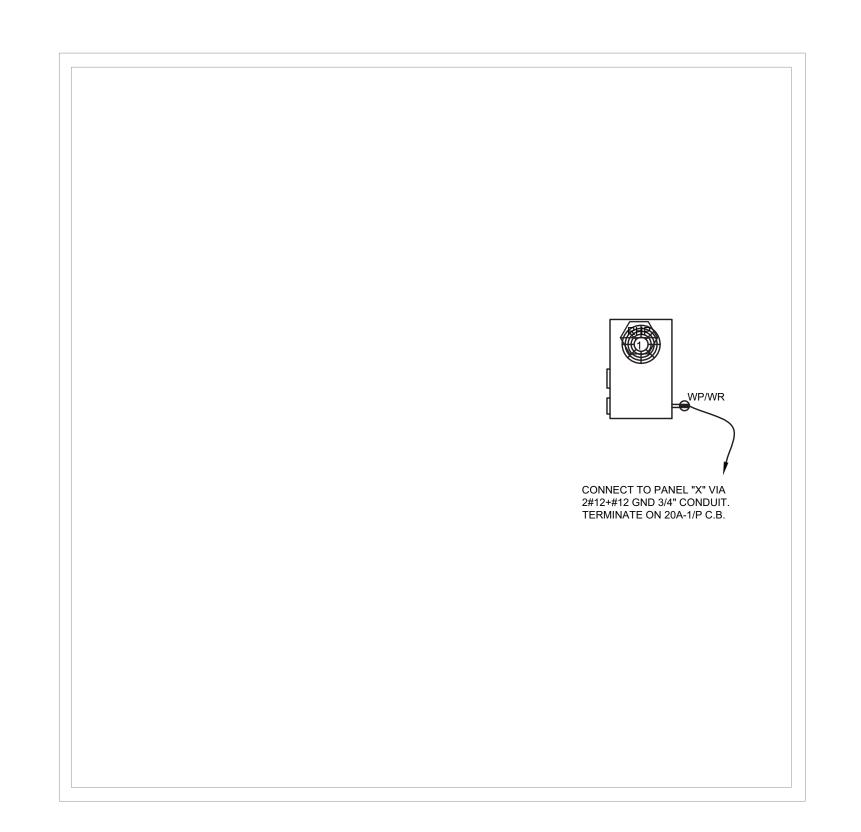


FLOOR PLANS
DEMOLITION
ELECTRICAL

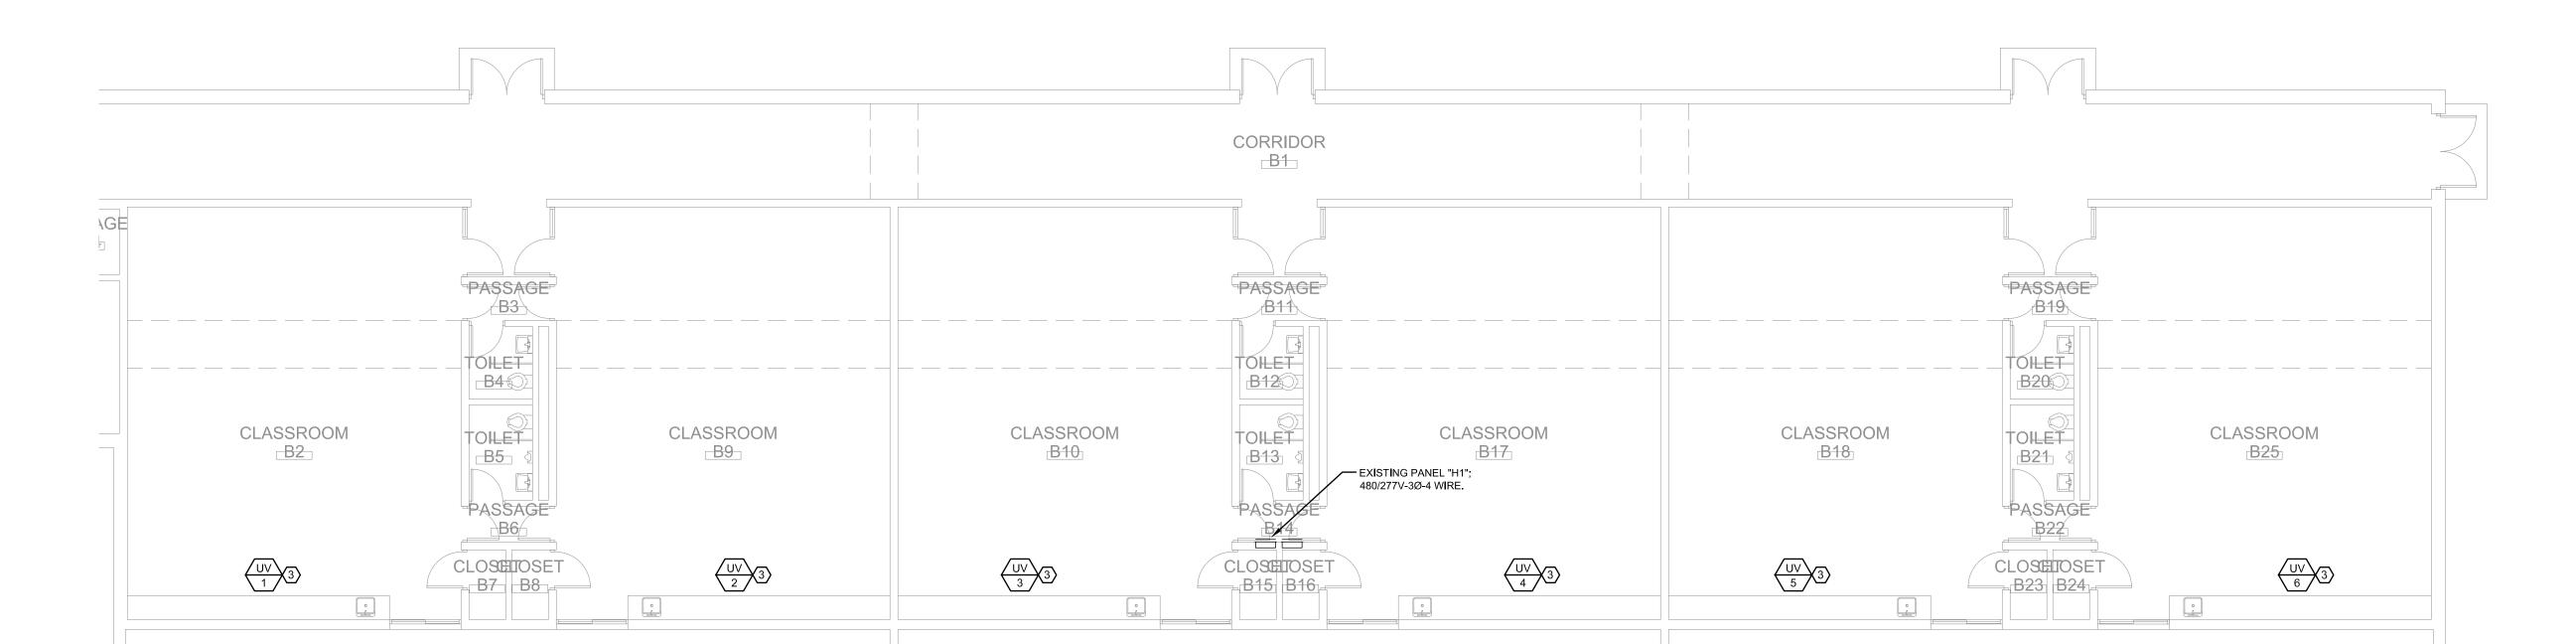

0' 4' 8'



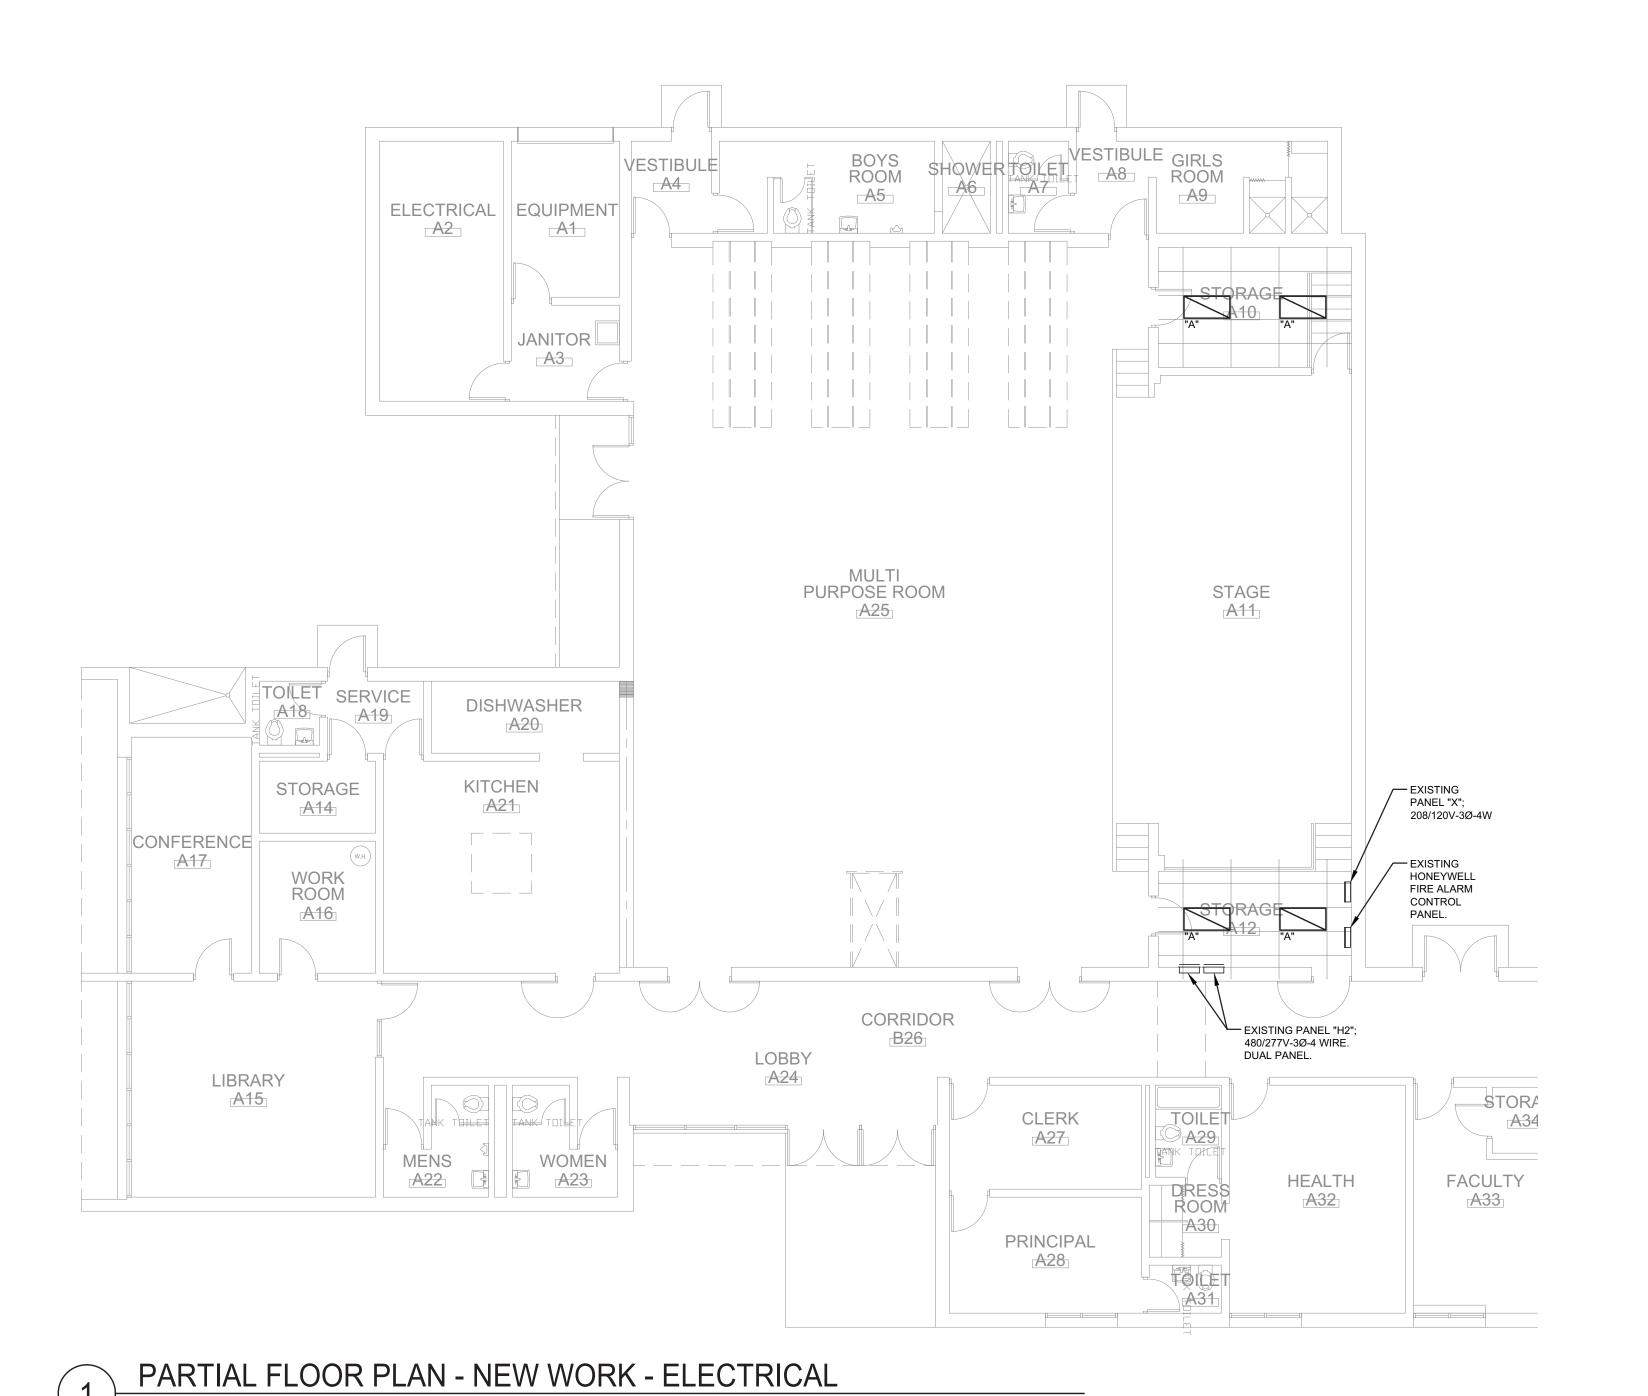

3 PARTIAL ROOF PLAN - NEW WORK - ELECTRICAL

SCALE: 1/8" = 1'-0"



ARCHITECTS

R G Architects, LLC

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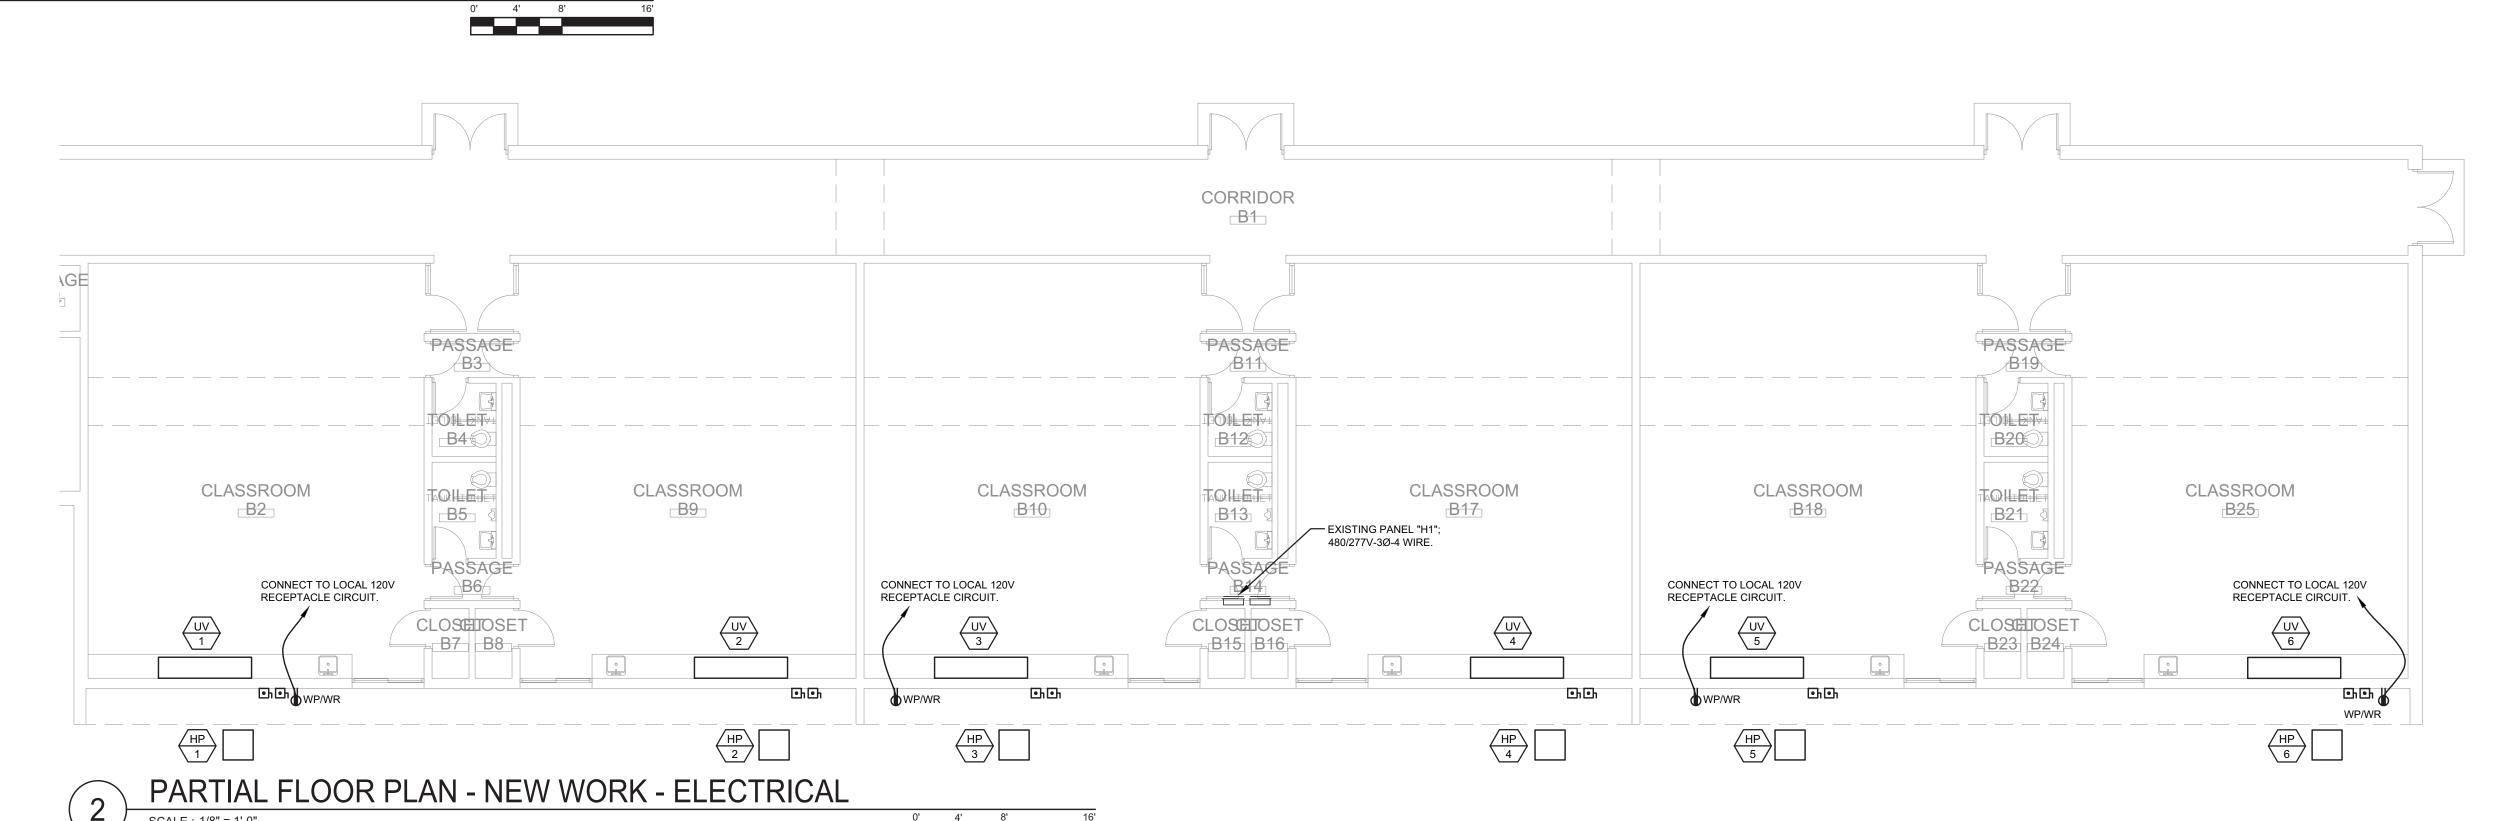
100 W. Mispillion Street Harrington, Delaware 19952

	<i>g., </i>
SHE	ET INFO:
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# Copyright - R G Architects - 2022

FLOOR PLANS
NEW WORK
ELECTRICAL





### **ELECTRICAL LEGEND**


DUPLEX RECEPTACLE WITH GROUND FAULT PROTECTION, HEIGHT AS DIRECTED BY ARCHITECT

ELECTRIC PANELBOARD SURFACE FLUSH MOUNTED

BRANCH WIRING CONCEALED WITHIN BUILDING

CIRCUIT HOMERUNS CONCEALED WITHIN THE BUILDING

FUSED DISCONNECT SWITCH

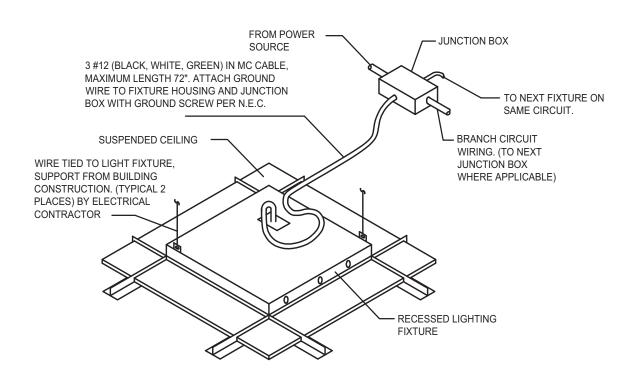

TYPICAL LAY-IN TROFFER DETAIL

ITEM	DESCRIPTION	HP	VOLTAGE	MCA	CIRCUIT BREAKER	WIRING	COMBINATION STARTER AND/OR DISCONNECT SWITCH	PANEL-CIRCUIT NUMBER	REMARKS
RHP-1	ROOF TOP HEAT PUMP	-	480V-3Ø	64A	(EX) 70/3	3#4 +#8 GND: 1 1/4" C.	FURNISHED BY MFGR	(EX) H2	1
UV-1	UNIT VENT	-	480V-3Ø	18.6A	(EX) 40/3	(EX) 3#8 +#10 GND: 3/4"C.	60A-3/P FUSED WP BY E.C.	(EX) H1	2
UV-2	UNIT VENT	-	480V-3Ø	18.6A	(EX) 40/3	(EX) 3#8 +#10 GND: 3/4"C.	60A-3/P FUSED WP BY E.C.	(EX) H1	2
UV-3	UNIT VENT	-	480V-3Ø	18.6A	(EX) 40/3	(EX) 3#8 +#10 GND: 3/4"C.	60A-3/P FUSED WP BY E.C.	(EX) H1	2
UV-4	UNIT VENT	-	480V-3Ø	18.6A	(EX) 40/3	(EX) 3#8 +#10 GND: 3/4"C.	60A-3/P FUSED WP BY E.C.	(EX) H1	2
UV-5	UNIT VENT	-	480V-3Ø	18.6A	(EX) 40/3	(EX) 3#8 +#10 GND: 3/4"C.	60A-3/P FUSED WP BY E.C.	(EX) H1	2
UV-6	UNIT VENT	-	480V-3Ø	18.6A	(EX) 40/3	(EX) 3#8 +#10 GND: 3/4"C.	60A-3/P FUSED WP BY E.C.	(EX) H1	2
HP-1	HEAT PUMP	-	480V-3Ø	6A	(EX) 40/3	(EX) 3#8 +#10 GND: 3/4"C.	60A-3/P FUSED WP BY E.C.	(EX) H1	2
HP-2	HEAT PUMP	-	480V-3Ø	6A	(EX) 40/3	(EX) 3#8 +#10 GND: 3/4"C.	60A-3/P FUSED WP BY E.C.	(EX) H1	2
HP-3	HEAT PUMP	-	480V-3Ø	6A	(EX) 40/3	(EX) 3#8 +#10 GND: 3/4"C.	60A-3/P FUSED WP BY E.C.	(EX) H1	2
HP-4	HEAT PUMP	-	480V-3Ø	6A	(EX) 40/3	(EX) 3#8 +#10 GND: 3/4"C.	60A-3/P FUSED WP BY E.C.	(EX) H1	2
HP-5	HEAT PUMP	-	480V-3Ø	6A	(EX) 40/3	(EX) 3#8 +#10 GND: 3/4"C.	60A-3/P FUSED WP BY E.C.	(EX) H1	2
HP-6	HEAT PUMP	-	480V-3Ø	6A	(EX) 40/3	(EX) 3#8 +#10 GND: 3/4"C.	60A-3/P FUSED WP BY E.C.	(EX) H1	2

NOTES:

NOTES:

1. ELECTRICAL CONTRACTOR SHALL FURNISH (2) FIRE ALARM DUCT DETECTORS TO THE MECHANICAL CONTRACTOR FOR INSTALLATION. (1) FOR SUPPLY AND (1) FOR RETURN. UPON COMPLETION OF INSTALLATION E.C. SHALL BE RESPONSIBLE FOR ALL FINAL CONNECTIONS TO UNIT AND FIRE ALARM CONTROL PANEL FOR UNIT SHUT DOWN. EXISTING CONTROL PANEL IS A HONEYWELL SYSTEM. ALL WORK TO BE COORDINATED WITH THE LOCAL SYSTEM REP. AND FIRE MARSHAL OFFICE.

2. MULTIPLE UNITS ON A SINGLE CIRCUIT. CONTRACTOR TO CONNECT OUTDOOR UNIT TO ITS RESPECTIVE INDOOR UNIT. MOUNT BOTH DISCONNECTS ON THE EXTERIOR. EXTEND EXISTING CIRCUIT IN KIND.

3. E.C. TO FUSE ALL EQUIPMENT PER MFGR. RECOMMENDATIONS.

## LIGHT FIXTURE SCHEDULE

#### NOTES

1. EQUIVALENT FIXTURE PACKAGES MAY BE SUBMITTED FROM THESE LIGHTING REPRESENTATIVES: DIGITAL ELEMENTS, DIVERSIFIED LIGHTING, ILLUMINATIONS, LIGHTING SOLUTIONS, AND PENN LIGHTING. FIXTURES SUBMITTED AS EQUIVALENTS SHALL BE OF THE SAME TYPE, DIMENSION, ACCESS TO DRIVERS, AND LAMPS, PERFORMANCE AND QUALITY OF THOSE SPECIFIED. EQUIVALENT MANUFACTURERS MUST MEET ALL CRITERIA OF THE BASE FIXTURE SPECIFIED. ANY DEVIATIONS WHICH DO NOT REFLECT THE BASE FIXTURE WILL RESULT IN A REJECTED SHOP DRAWING DURING SUBMITTAL PERIOD.

2. ALL FIXTURE COLORS, FINISHES, AND MOUNTING HEIGHTS SHALL BE VERIFIED WITH THE ARCHITECT PRIOR TO APPROVAL OF SHOP DRAWINGS.

3. ALL LED DRIVERS SHALL BE INTEGRAL HIGH EFFICIENCY UNIVERSAL INPUT VOLTAGE DRIVERS, RATED FOR 50,000 HOURS AT 70% LUMEN MAINTENANCE, UNLESS NOTED OTHERWISE.

TYPE	MANUFACTURER	CATALOG NUMBER	LAMPS	MOUNTING	OPERATING VOLTAGE	REMARKS	
А	LITELINE	LEDP-24-WH-40-50-120/277	50W LED, 4000°K, 6320 LUMENS, CRI 80+	RECESSED, CEILING	UNV	2'W X 4'L LED FLAT PANEL, ALUMINUM FRAME, T-BAR MOUNTING, OPAL PMMA LENS, 0-10V DIMMING.	



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SCHEDULES, DETAILS, LEGENDS ELECTRICAL

