
## O.M.B. / D.F.M. STATE OF DELAWARE CONTRACT NO. MC1002000770

# THOMAS COLLINS BUILDING ELEVATOR UPGRADES

540 S. DUPONT HIGHWAY DOVER, DELAWARE 19901

> BID SET JUNE 5, 2023

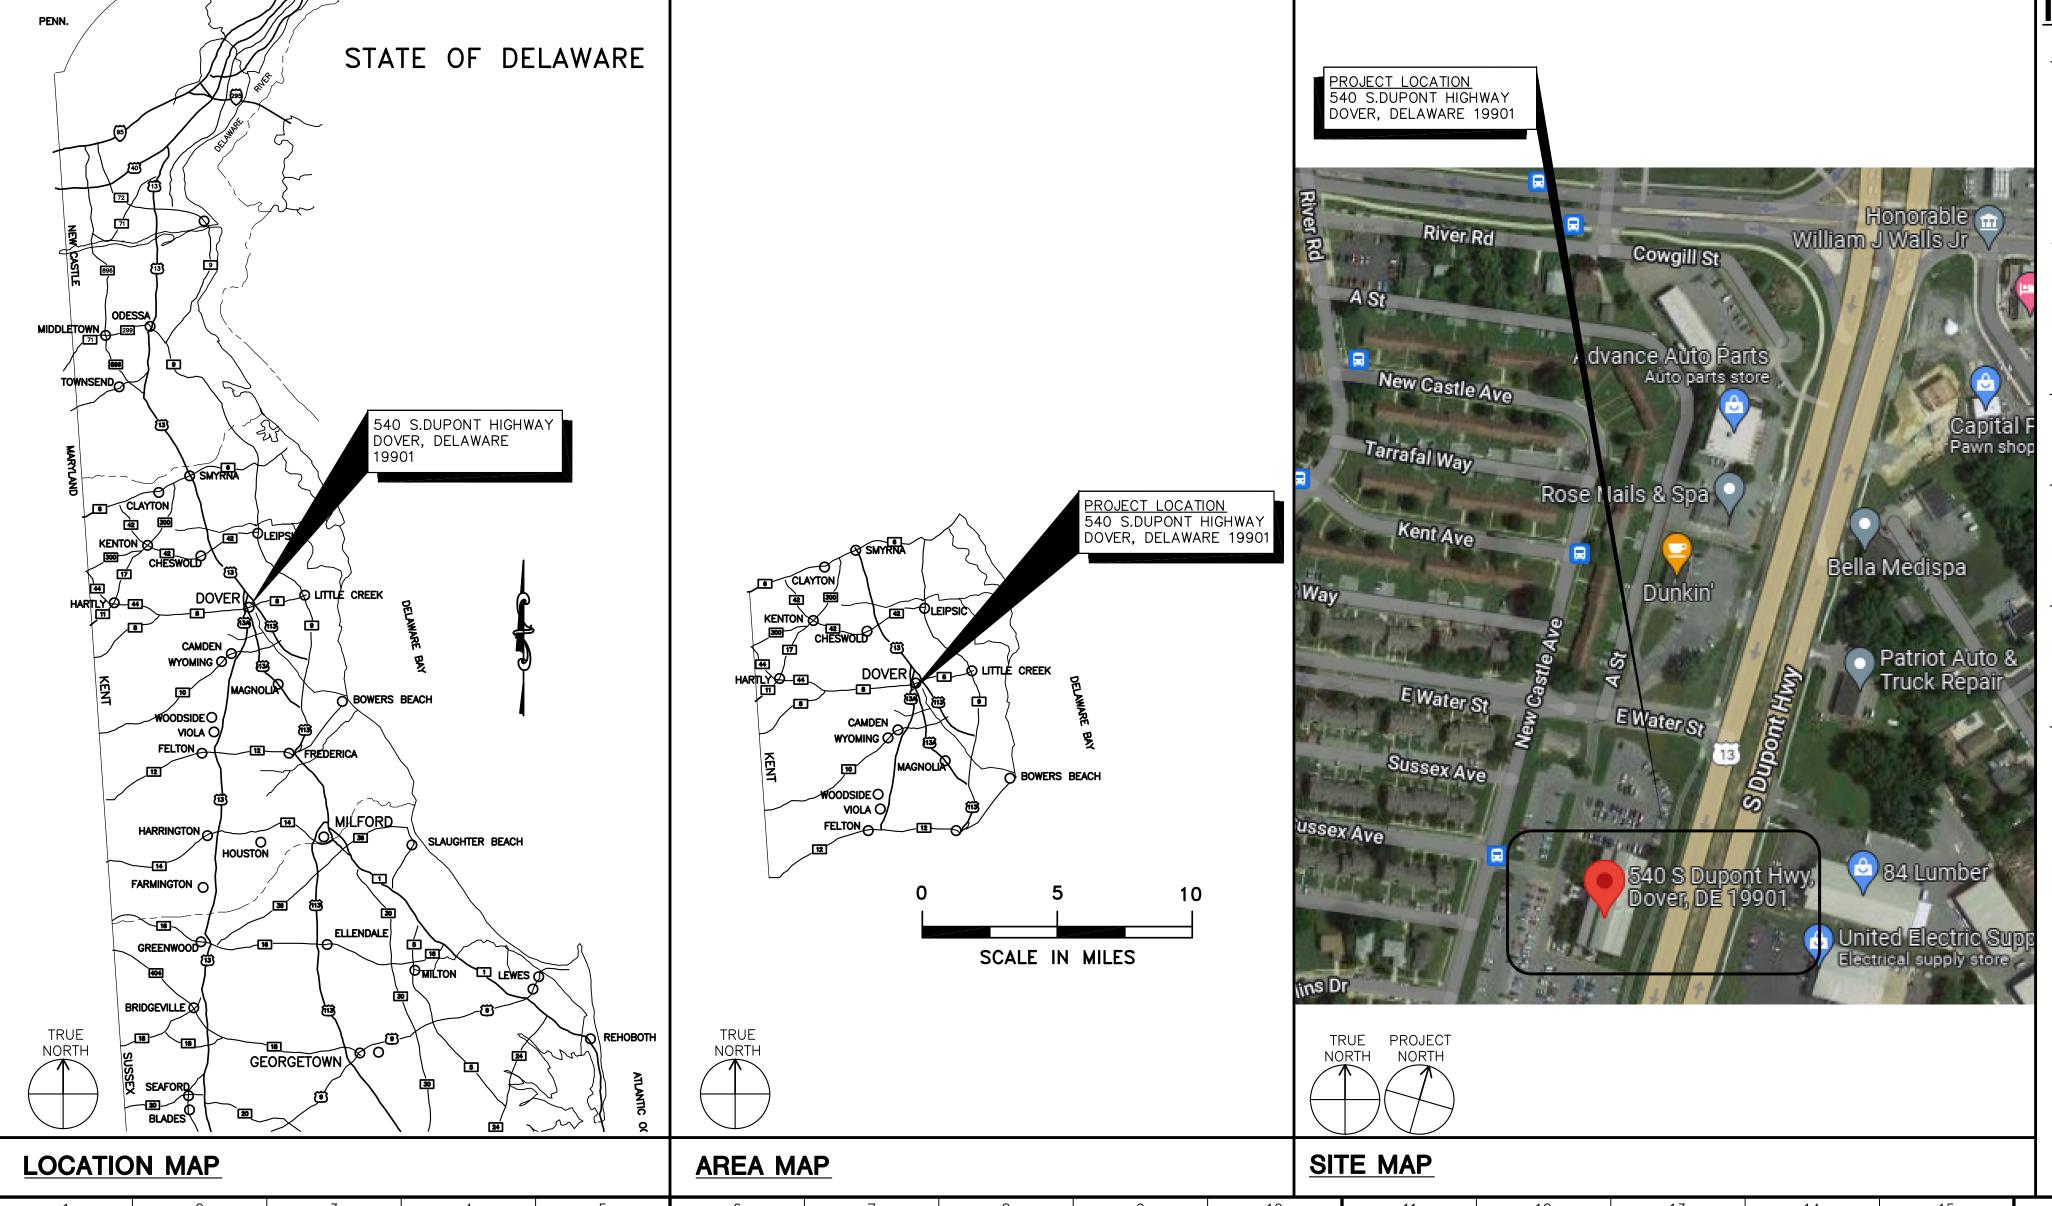

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- SINGLE LINE DIAGRAM, SCHEDULES & DETAILS



ARCHITECTS, ENGINEERS & SURVEYORS

## FAYDA ENGINEERING & ENERGY SOLUTIONS, LLC

801 W. Newport Pike, Wilmington, DE 19804 Tel: 302-999-1060, Fax: 302-999-1053 www.FaydaEES.com

#### GENERAL NOTES:


. SCOPE OF WORK INCLUDES WORK SHOWN IN THESE DRAWINGS AND THE PROJECT SPECIFICATIONS. ALL WORK NOTED SHALL BE BASE BID UNLESS NOTED OTHERWISE.

- THE CONTRACTOR SHALL VERIFY ALL EXISTING CONDITIONS
   AND DIMENSIONS BEFORE CONSTRUCTION. ANY VARIATIONS
   OR DISCREPANCIES SHALL BE BROUGHT TO THE ARCHITECT'S
   ATTENTION PRIOR TO CONSTRUCTION.
- 3. ANY CHANGE OR FIELD ALTERATION SHALL BE BROUGHT TO THE ATTENTION OF THE ARCHITECT PRIOR TO CONSTRUCTION
- 4. ANY ITEMS NOT SPECIFICALLY SHOWN ON THE DRAWINGS, BUT WHICH ARE REASONABLY INCIDENTAL TO AND NECESSARY FOR THE SATISFACTORY COMPLETION OF THE PROJECT IN ACCORDANCE WITH INDUSTRY STANDARDS & JURISDICTIONAL CODE, ARE INCLUDED WITHIN THE INTENT OF THESE DRAWINGS
- OWNER'S ENVIRONMENTAL CONTRACTOR WILL BE RESPONSIBLE FOR TESTING AND REMOVAL OF HAZARDOUS
- 6. THE CONTRACTOR IS RESPONSIBLE FOR PROVIDING ALL NECESSARY SHORING, BRACING, AND CONSTRUCTION AIDS FOR DEMOLITION AND NEW CONSTRUCTION.
- 7. THE CONTRACTOR IS RESPONSIBLE FOR MAINTAINING ALL AREAS IN AND AROUND THE AREA OF WORK AND SECURE ALL MATERIALS AND EQUIPMENT. SPECIAL CARE SHOULD BE TAKE! NOT TO LEAVE HAZARDOUS CONDITIONS POTENTIALLY DANGEROUS TO THE PUBLIC
- DANGEROUS TO THE PUBLIC.

  8. BUILDING SHALL REMAIN OCCUPIED DURING CONSTRUCTION.
  PROTECTIVE MEASURES SAFEGUARDING VISITORS AND
  OCCUPANTS SHALL BE PROVIDED BY THE CONTRACTOR AS
- 9. TEMPORARY DISRUPTION OF SERVICES THAT MAY BE REQUIRED DURING THE WORK SHALL NOT PROCEED WITHOUT PRIOR COORDINATION WITH THE OWNER.

REQUIRED WITHIN AND AROUND THE AREA OF WORK.

IO. PROJECT PHASING: ALL WORK ASSOCIATED WITH ELEVATOR #2, THE HOISTWAY AND THE ELEVATOR MACHINE ROOM SHALL BE INCLUDED IN PHASE I. ALL WORK ASSOCIATED WITH ELEVATOR #I SHALL BE INCLUDED IN PHASE 2.

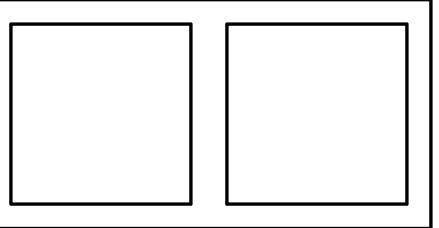

Revision

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## O.M.B. / D.F.M. THOMAS COLLINS BUILDING ELEVATOR UPGRADES


540 S. DUPONT HIGHWAY DOVER, DELAWARE 19901 STATE CONTRACT NO: MC1002000770


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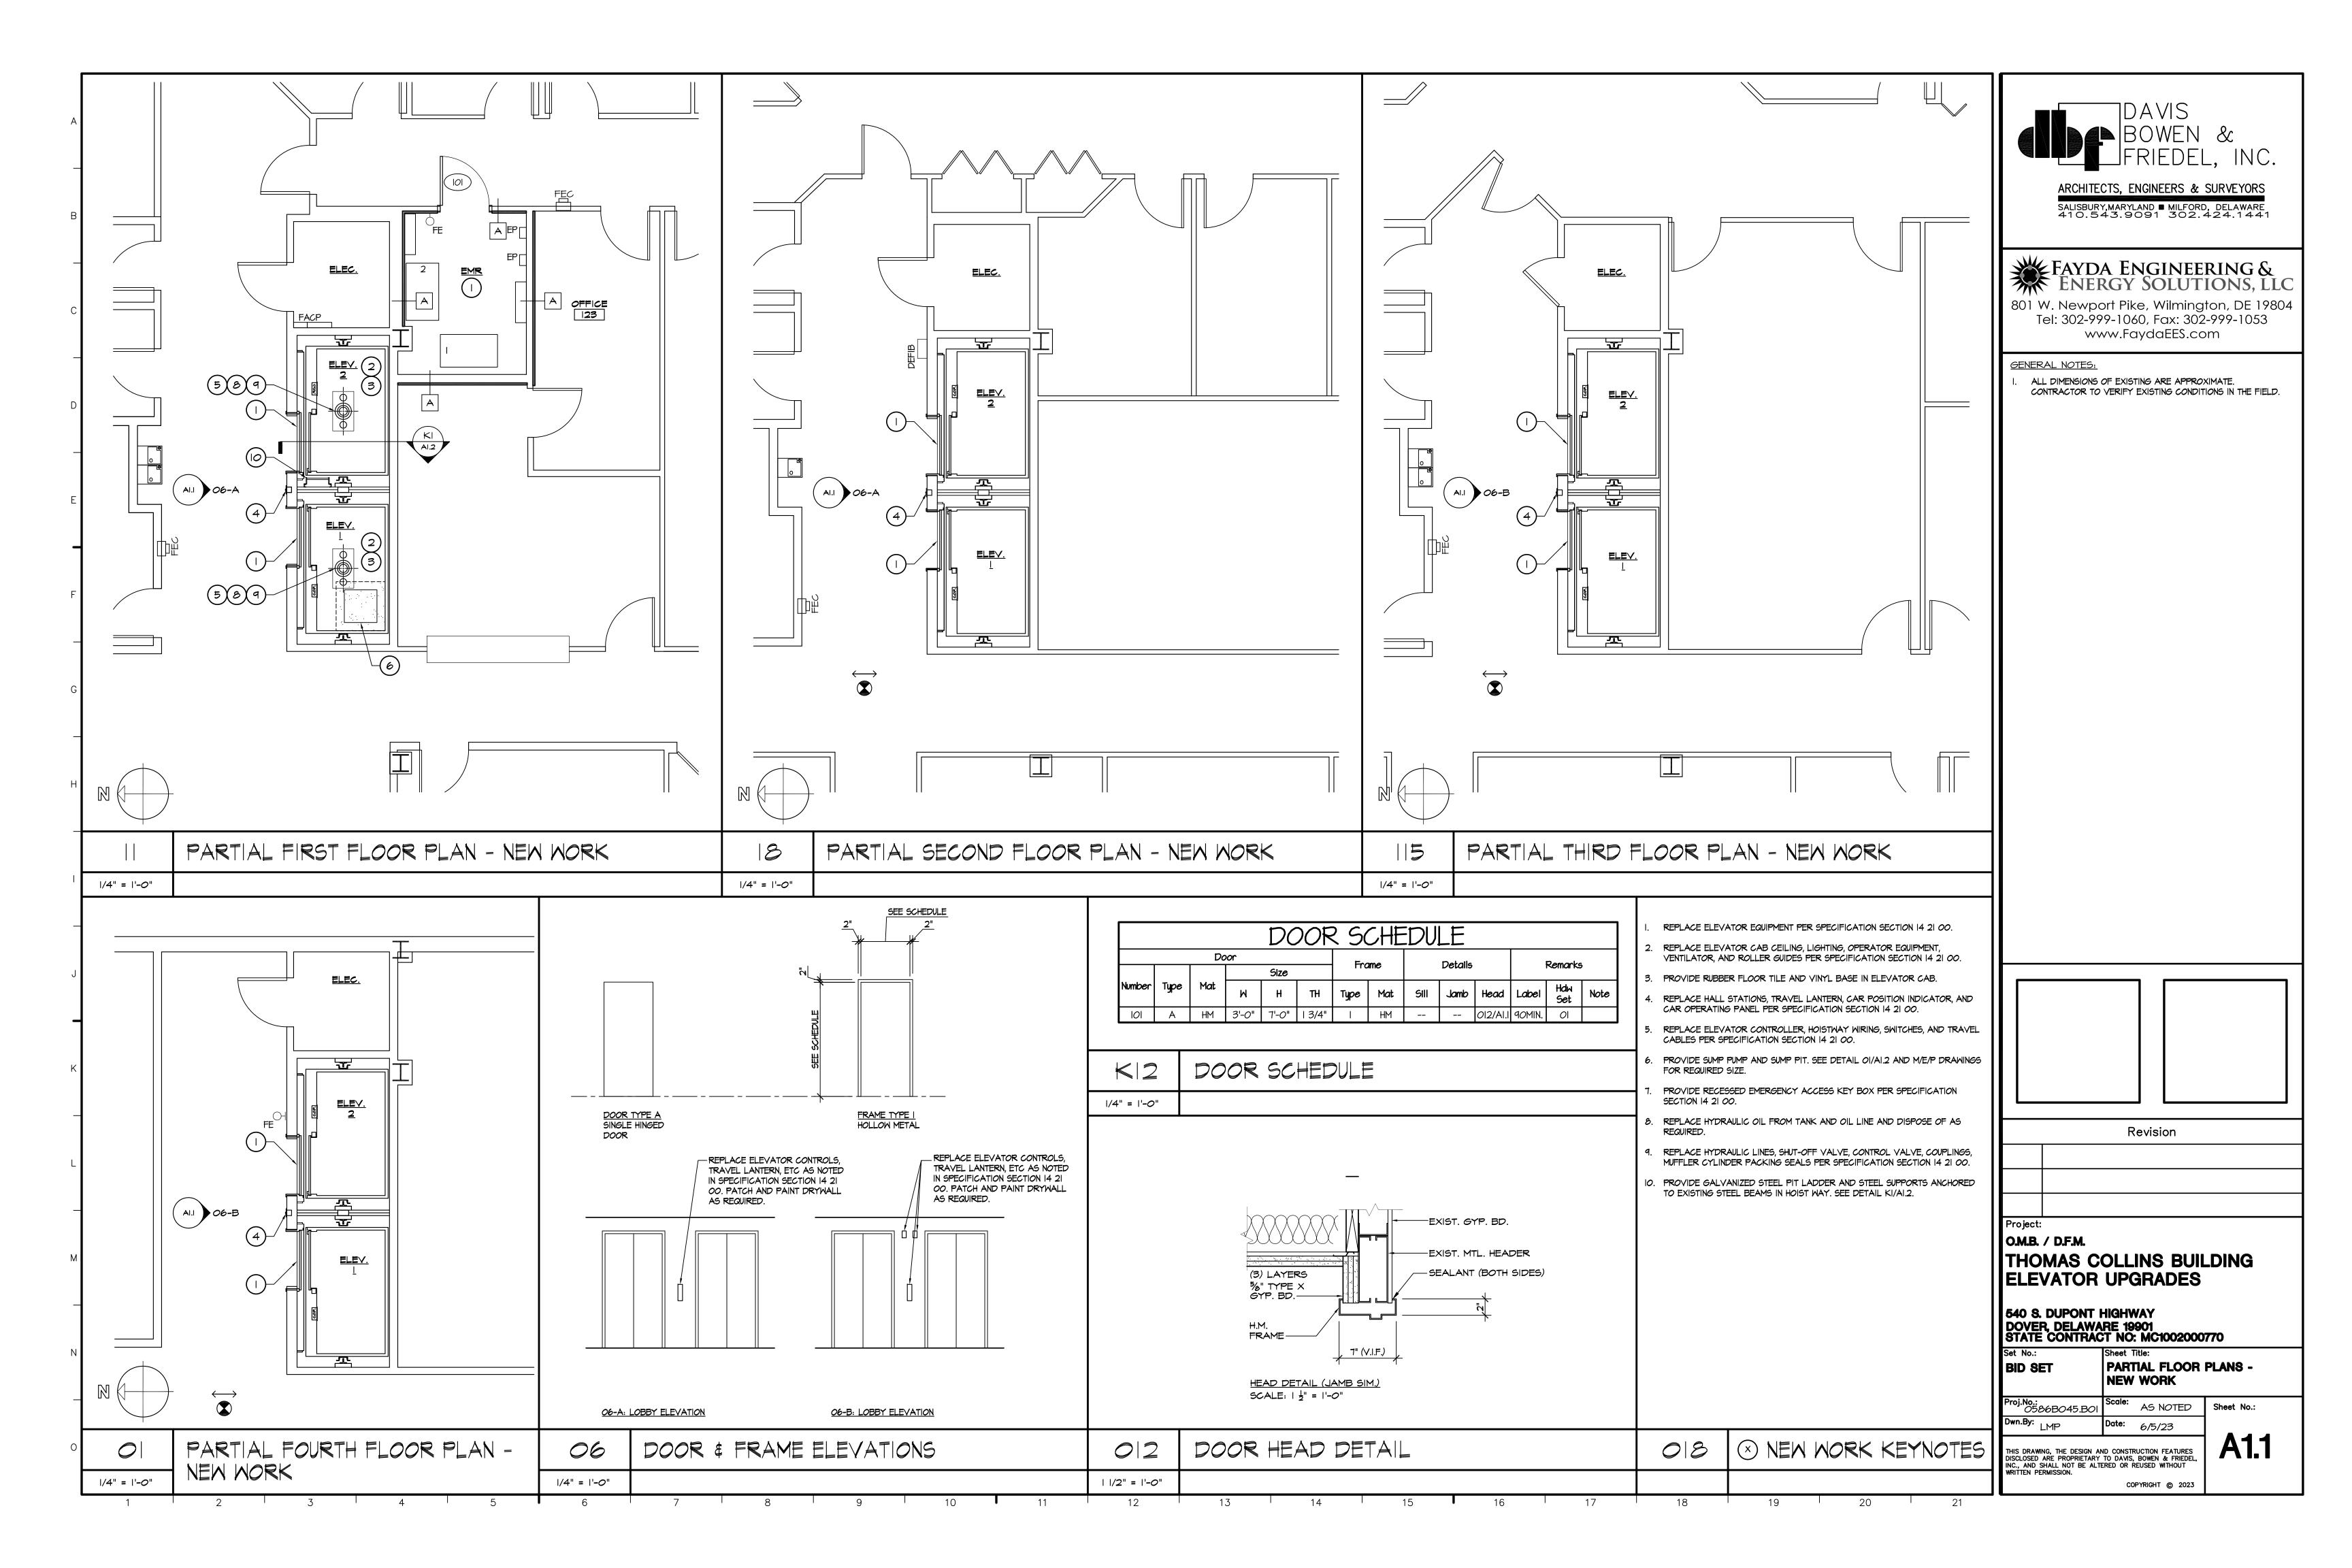
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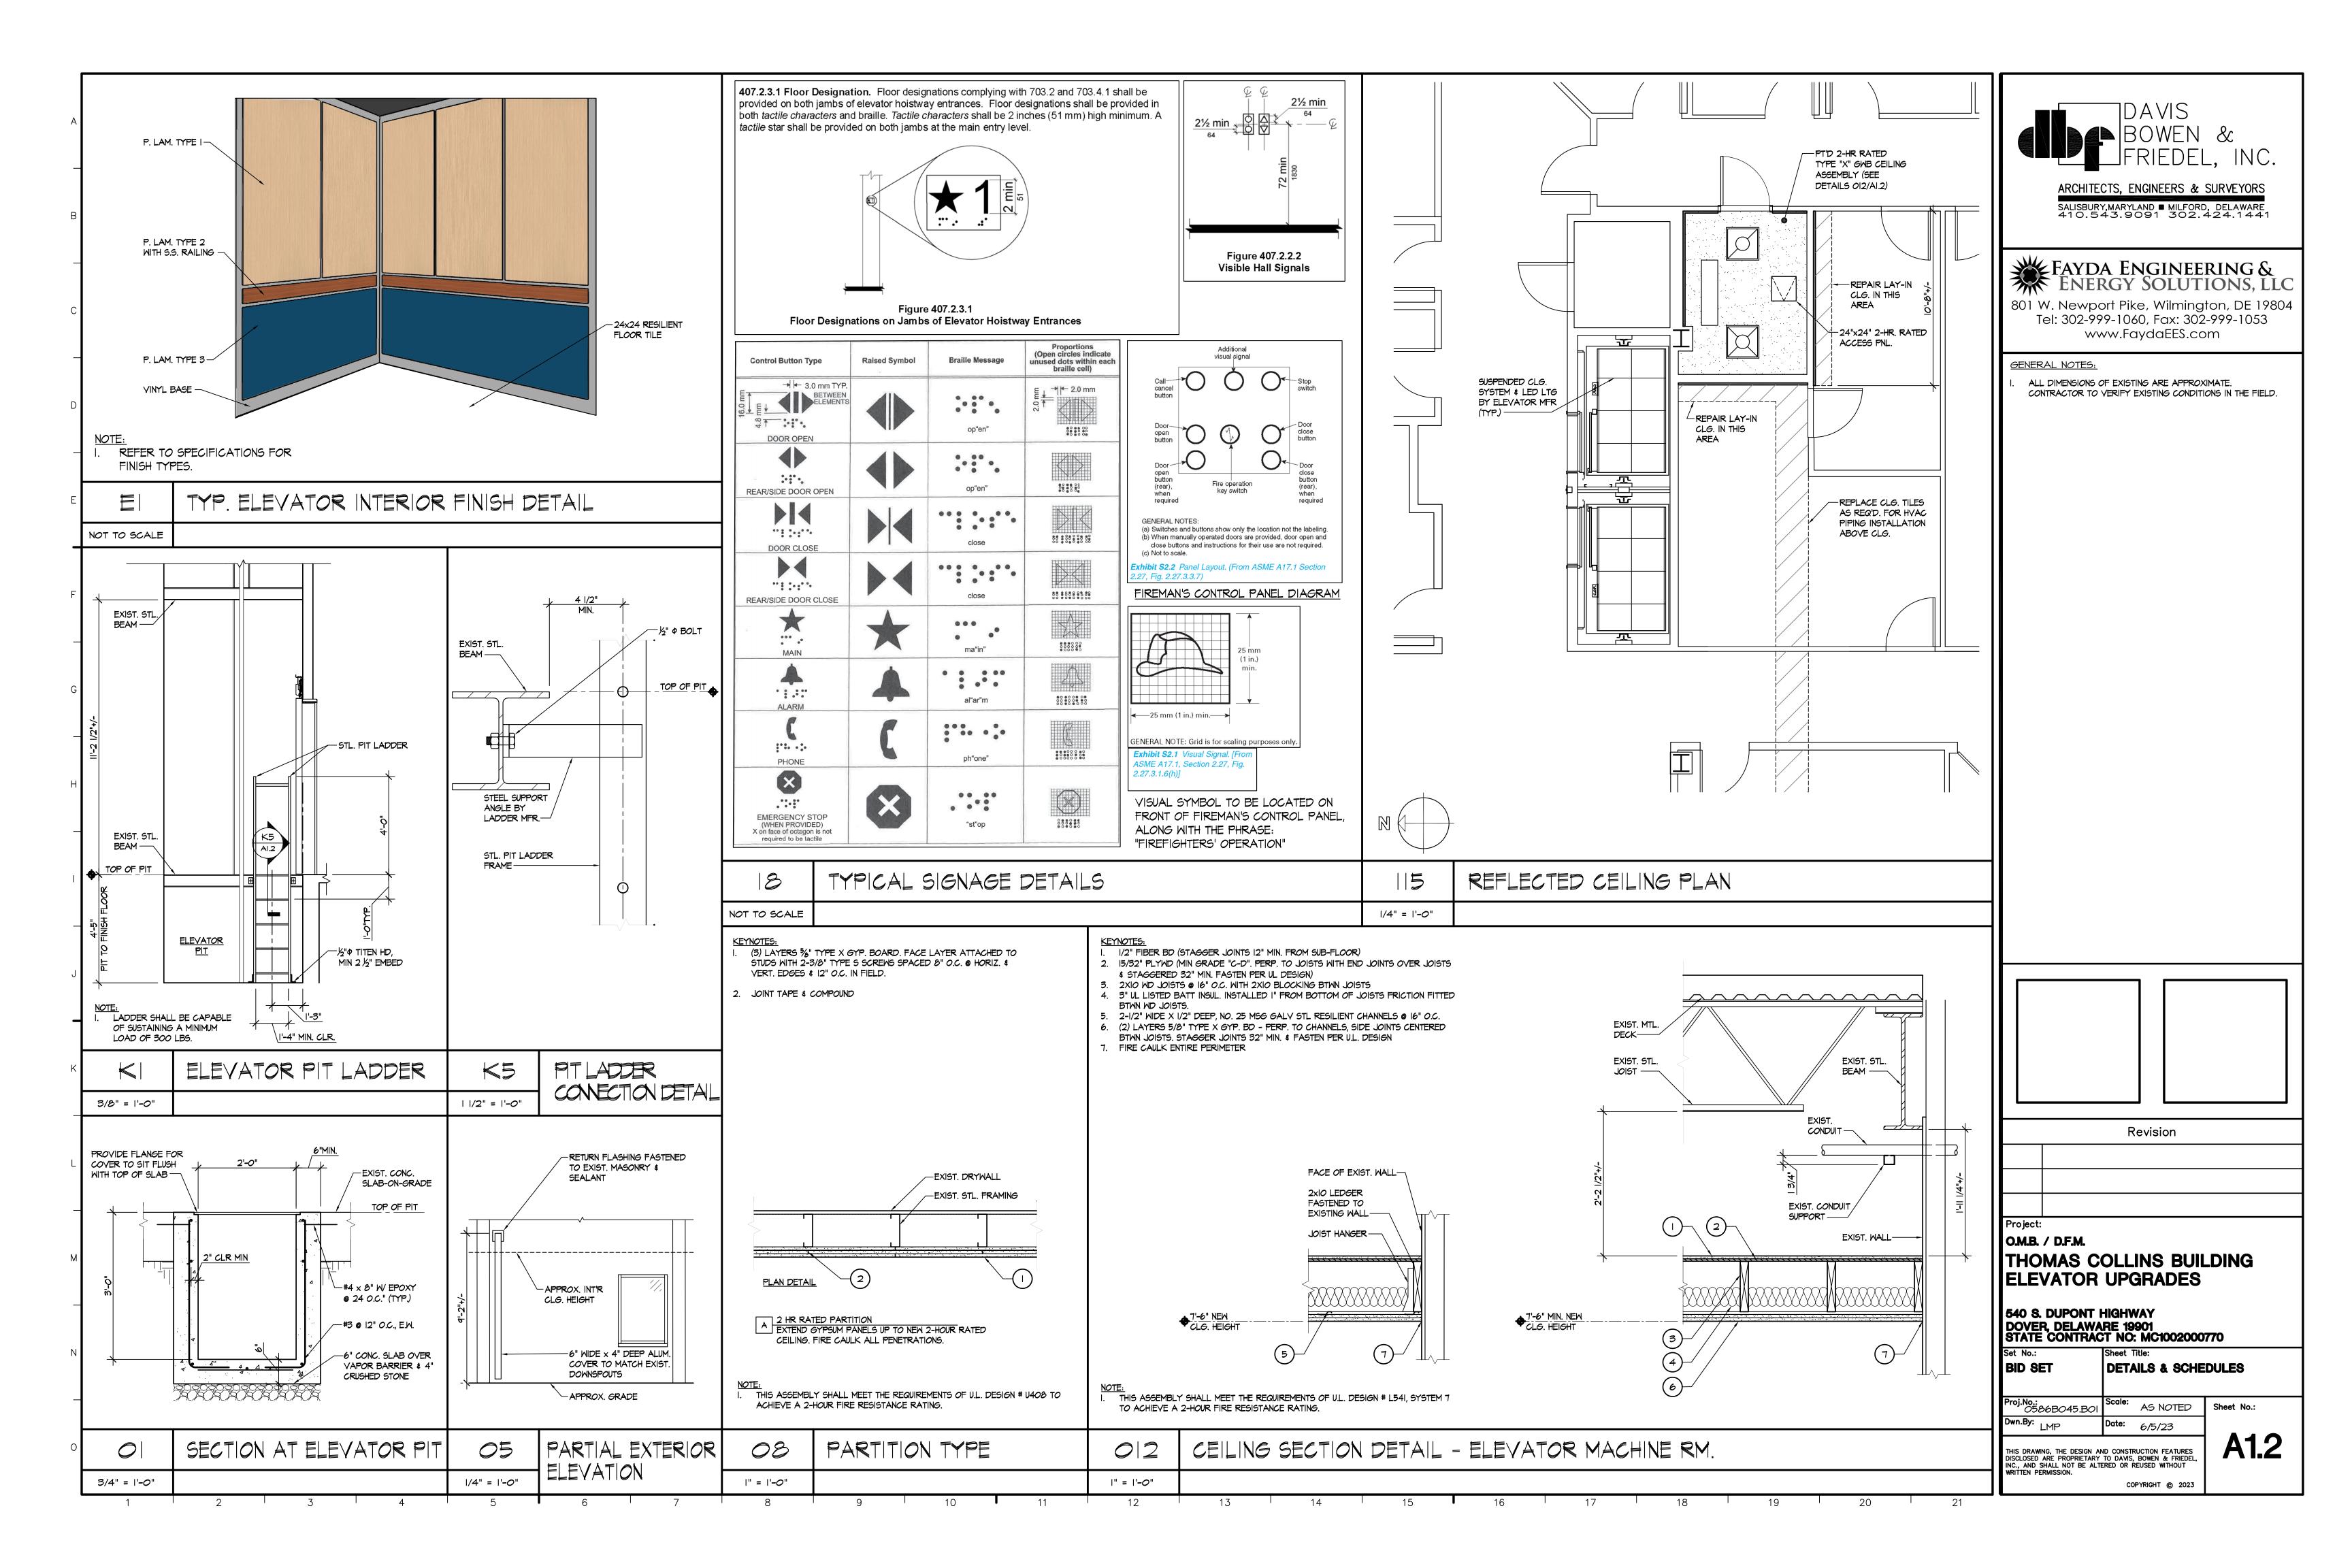
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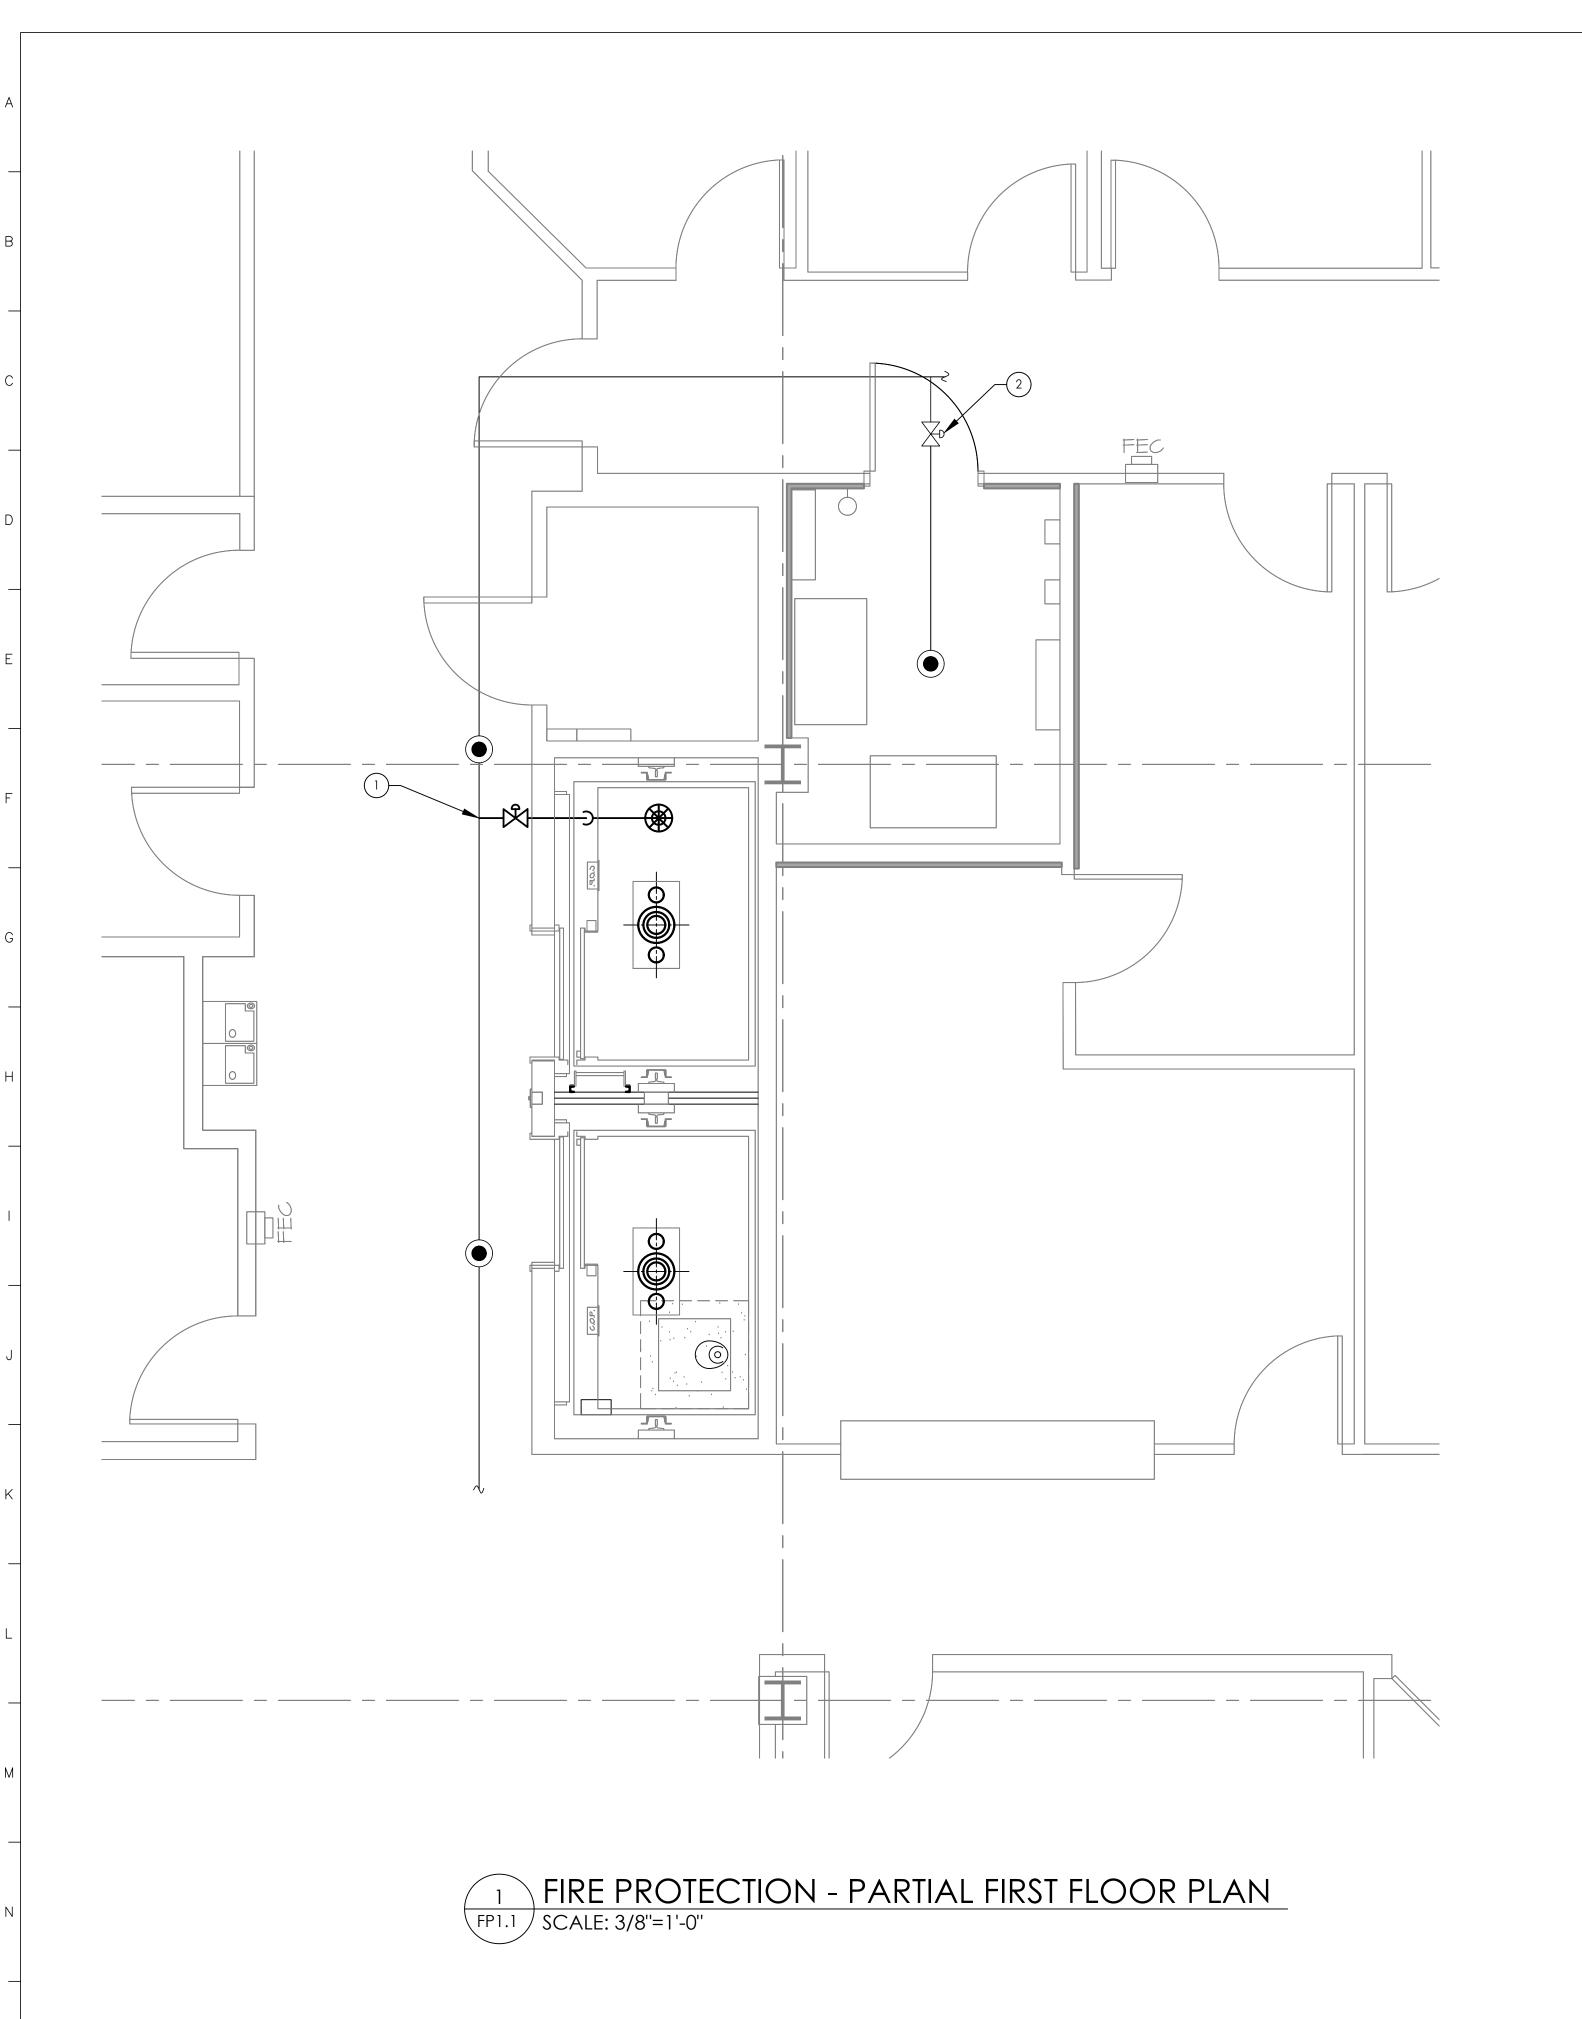
	ZDIC				MATERIAL LEGEND	SYMBOLS LEGEND	CODE DATA	
ARCHITECTURAL WORK							I. APPLICABLE CODES:	DAVIS
DRAWING ABBREVIATION SYMBOLS used as abbrevia					MASONRY IN ELEVATION	DRAWING KEYNOTE	I. APPLICABLE CODES:  INTERNATIONAL BUILDING CODE 2018  LIFE SAFETY - NFPA 101 (2021)	BOWEN &
– ∠ angle	DP damp proofing	HOR horizontal	PT point	VCT vinyl composition tile		EXISTING STUD OR MASONRY WALL	DE STATE FIRE PREVENTION REGULATIONS (2021) ICC/ANSI AIIT.I (2012)	FRIEDEL, INC.
€ centerline d penny	DL dead load DEM demolish, demolition	HB hose bib H√ heat ventilator	PVC polyvinyl chloride PCF pounds per cubic foot	∨B vinyl base ∨⊤ vinyl tile	CONCRETE IN PLAN OR  DRYWALL IN PLAN OR SECTION		INTERNATIONAL ENERGY CONSERVATION CODE 2018 INTERNATIONAL MECHANICAL CODE 2018	ARCHITECTS, ENGINEERS & SURVEYORS
B \(\perp \) perpendicular	DTL detail	HMH hot water heater	PLF pounds per lineal foot			TYPES FOR REQUIREMENTS)	INTERNATIONAL PLUMBING CODE 2021 STATE OF DE ARCHITECTURAL ACCESSIBILITY	SALISBURY,MARYLAND ■ MILFORD, DELAWARE 410.543.9091 302.424.1441
PL plate ⊘ round	DIAG diagonal DIAM diameter	INCL include (d) (ing)	PSF pounds per square foot PSI pounds per square inch	MSCT wainscot MH wall hung	CONCRETE IN SECTION	NEW STUD WALL (SEE PARTITION TYPES FOR REQUIREMENTS)	STANDARDS ADAAG ADA ACCESSIBLE GUIDELINES FOR BUILDINGS	
	DR door	inside diameter	PSL parallel strand lumber	₩ washing machine			AND FACILITIES ASME AI7.I-2013 AND ASME AI8.I-2008 AS CURRENTLY	W =
ABBREVIATIONS ABV above	DA double acting  DH double hung	INS insulate (d) (ion) INT interior	P/C pre-cast PFB prefabricated	WC water closet WP waterproofing	EARTH IN SECTION	DOOR TAG (SEE DOOR SCHEDULE)	ADOPTED IN THE 2015 INTERNATIONAL BUILDING CODE, AS AMENDED BY NEW CASTLE COUNTY AND THE NEW CASTLE	FAYDA ENGINEERING & ENERGY SOLUTIONS, LLC
AFF above finish floor	DN down	INV invert	PFN prefinished	MS waterstop	WOOD (ROUGH) IN SECTION	XX PARTITION TYPE	COUNTY PROPERTY MAINTENANCE CODE.	801 W. Newport Pike, Wilmington, DE 19804
C ACC access ACFL access floor	DS downspout D drain	JC janitor's closet	PRF preformed PRTR pressure treated wood	MMF welded wire fabric W west			II. BUILDING DATA:	Tel: 302-999-1060, Fax: 302-999-1053
AP access panel	DT drain tile	JT joint	PL property line	WHB wheel bumper	7/////////BRICK IN SECTION	X WINDOW TYPE	A. IBC CLASSIFICATION = BUSINESS (B) NFPA CLASSIFICATION: EXISTING BUSINESS	www.FaydaEES.com
AC acoustical  ACT acoustical tile	DWR drawer DWG drawing	J joist	QT quarry tile	MTH wide, width M/ with		ROOM TAG	B. CONSTRUCTION TYPE: IBC: 2-B	GENERAL NOTES:
ACD addendum	DF drinking fountain	KPL kickplate		MIN window	CONCRETE MASONRY UNIT IN SECTION	XXX X	NFPA: 2	I. SEE M/E/P DRAWINGS FOR SYMBOLS AND ABBREVIATIONS PERTAINING TO THOSE DISCIPLINE
ADH adhesive D ADJ adjacent	D dryer	KIT kitchen K⊘ knockout	RL rail (ing) RMC rain water collector	MG wired glass MM wire mesh		ROOM FINISH DESIGNATION	C. NUMBER OF STORIES: 4	
ADJT adjustable	EF each face		REF reference	WO without	BATT INSULATION		D. BUILDING HEIGHT: LESS THAN 75 FEET	
AGG aggregate  A/C air conditioning	E east  ELEC electric (al)	LBL label LAD ladder	RFL reflect (ed) (ive) (or) REFR refrigerator	MD wood MB wood base	IN SECTION		E. SPRINKLERED: YES	
ALT alternate	EP electrical panelboard	LB lag bolt	REG register	WPT working point	RIGID INSULATION	FE 2A: IOBC MINIMUM RATED WALL	F. ELEVATOR TYPE: EMERGENCY RECALL ELEVATOR PHASE   & 2.	
AL aluminum ANC anchor, anchorage	EMC electric water cooler EL elevation	LAM laminate LA∨ lavatory	REINF reinforce (d) (ing) RCP reinforced concrete pipe		IN SECTION	$\Omega$ MOUNTED FIRE EXTINGUISHER		
AB anchor bolt	ELEV elevator	LH left hand	ROW right-of-way		THE LICENT PRINCIPLE OF STREET	FEC FIRE EXTINGUISHER CABINET	V. FIRE RESISTIVE RATINGS FOR BUILDING ELEMENTS	
ANDO anodized  APX approximate	EMER emergency ENC enclose	L length LT light	RES resilient RET return		))))))))) WOOD (FINISH) IN SECTION		A. ELEVATOR SHAFT: 2 HR	
ARCH architect (ural)	EQ equal	LTL lintel	RA return air			CG CORNER GUARD	B. ELEVATOR MACHINE ROOM: 2 HR C. ELEVATOR & MACHINE RM DOORS: 90 MIN	
AD area drain ASB asbestos	EQP equipment EST estimate	L√R louver LL live load	RE√ revision (s), revised RH right hand		EXIST. 2X4 SUSPENDED  ACOUSTICAL CEILING		VI. MISCELLANEOUS FIRE PROTECTION FEATURES:	
F ASPH asphalt	EXCA excavate		ROW right of way		TILE	X TOILET ACCESSORIES TAG	A. INTERIOR FINISHES	
AUTO automatic	EXH exhaust EXG existing	MH manhole MFR manufacture (er)	R riser RD roof drain				ELEVATOR CABS:  MACHINE ROOMS:  A OR B  B. FIRE ALARM:  REQUIRED	
BP back plaster (ed)	EJT expansion joint	MAD masonry	RFL roof hatch		NEW 2X2 SUSPENDED ACOUSTIC	ELEVATION	C. PANIC HARDWARE (MACHINE RM): NOT REQUIRED	
BSMT basement BRG bearing	EB expansion bolt EXP exposed	MO masonry opening MTL material (s)	RFG roofing RM room		CEILING TILE & GRID	XX = SHEET NUMBER YY = ELEVATION NUMBER	D. EMERGENCY LIGHTING: REQUIRED	
BPL bearing plate	EXT exterior	MAX maximum	RO rough opening				VII. <u>ALTERATION LEVEL</u> IEBC ALTERATION LEVEL: 2	
G BM bench mark BEL below	FE fire extinguisher	MECH mechanic (al)  MC medicine cabinet	RB rubber base		NEW GYP. BOARD CEILING		ALL NEW WORK SHALL COMPLY WITH MATERIALS AND	
BET between	FEC fire extinguisher cabinet	MBR member	SCHED schedule			(+ X'-X") CEILING HEIGHT ABOVE FINISHED FLOOR	METHODS REQUIREMENTS IN THE INTERNATIONAL BUILDING CODE, INTERNATIONAL ENERGY CONSERVATION CODE,	
→ BVL beveled BIT bituminous	FOF face of finish FOM face of masonry	MMB membrane MET metal	SNT sealant SECT section				INTERNATIONAL MECHANICAL CODE, AND INTERNATIONAL PLUMBING CODE.	
BLK block	FOS face of studs	MFD metal floor decking	SSK service sink				VIII. COMMERCIAL ENERGY EFFICIENCY (IECC):	
H BLKG blocking BD board	FF factory finish FAS fasten, fastener	MTFR metal furring MRD metal roof decking	SHTH sheathing SHT sheet			NORTH ARROW	APPLICABILITY: ADDITIONS, ALTERATIONS, RENOVATIONS, OR	
BS both sides	FN fence	MTHR metal threshold	SG sheet glass		GRAPHIC SYMBOL LEGEND		REPAIRS TO AN EXISTING BUILDING, OR PORTION THEREOF SHALL CONFORM TO THE REQUIREMENTS OF THE IECC AS	
BM both ways BOT bottom	FBD fiberboard FGL fiberglass	MMK millwork MIN minimum	SH shelf, shelving SHO shore (d) (ing)				THEY RELATE TO NEW CONSTRUCTION WITHOUT REQUIRING THE UNALTERED PORTIONS OF THE EXISTING BUILDING OR	
BRK brick	FRP fiberglass reinforced plastic	MIR mirror	SIM similar			SECTION DETAIL	SYSTEMS TO COMPLY WITH THE IECC.	
BRZ bronze BLDG building	FIN finish (ed) FFE finished floor elevation	MISC miscellaneous MOD modular	SKL skylight SL sleeve				IX. ACCESSIBILITY	
BUR built up roofing	FFL finished floor line	MLD molding, moulding	SC solid core		HIDDEN LINE		A. EXISTING ELEVATOR CAR MINIMUM DIMENSIONS: CLEAR FLOOR AREA: 16 S.F. MINIMUM DEPTH: 51 INCHES	
BBD bulletin board	FA fire alarm FE fire extinguisher	MR mop receptor MT mount (ed) (ing)	S south SPC spacer		DEMOLITION		MINIMUM DEPTH: 51 INCHES MINIMUM WIDTH: 68 INCHES ACTUAL DEPTH: 51 INCHES	
CAB cabinet CPT carpet	FEC fire extinguisher cabinet	MOV movable	SPL special		DEMOCRITION		ACTUAL MIDTH: 80 INCHES	
CPT carpet CSMT casement	FPL fireplace FLG flashing	MUL mullion	SPEC specification (s) SQ square		A COLUMN LINE		B. BUTTONS: 3/4" MINIMUM BUTTON IN DIAMETER C. EMERGENCY CONTROLS: 35" MINIMUM ABOVE	
J CIPC cast-in-place-concrete	FLR floor (ing) FLCO floor cleanout	NAT natural NOM nominal	SST stainless steel STD standard				FLOOR LOCATED AT BOTTOM OF PANEL, ALONG WITH EMERGENCY ALARM.	
CB catch basin CK caulking	FD floor drain	NOM nominal N north	STL steel				D. CONTROL BUTTONS SHALL BE IDENTIFIED WITH TACTILE CHARACTERS, AND SHALL BE 42" ABOVE FINISHED	
CLG ceiling  CHT ceiling height	FLPL floor plate FLUR flourescent	NIC not in contract NTS not to scale	STOR storage SD storm drain		,-1		FLOOR. E. SEE DETAIL ON SHEET AI.2 FOR CONTROL BUTTON	
CEM cement	FT6 footing		STRUCTstructural		EXISTING WALL AND  ===== DOOR TO BE REMOVED		IDENTIFICATION REQUIREMENTS.	
PCPL cement plaster (portland)  K CTR center	FND foundation FR frame (d) (ing)	OBS obscure OC on center (s)	SYM symmetry (ical) SYS system					
CER ceramic	FBO furnished by others	OP opaque			EXISTING WALL AND			
CT ceramic tile  CMT ceramic mosaic tile	FUR furred (ing) FUT future	OPG opening OJ open-web joist	TKBD tackboard TEL telephone		DOOR TO REMAIN			╽ <b>╽</b> └──────
CHBD chalkboard		OPP opposite	T∨ television		NEW WALL OR DRYWALL			Revision
CHAM chamfer CIR circle	<ul><li>GA gage, gauge</li><li>G∨ galvanized</li></ul>	<ul><li>OPH opposite hand</li><li>OD outside diameter</li></ul>	TZ terazzo THK thick (ness)		OVER EXISTING STUDS			
CIRC circumference	GC general contract (or)	OA overall	THRES threshold					
CLR clear or clearance COL column	GL glass, glazing GLB glass block	OH overhead	TPTN toilet partition TPD toilet paper dispenser					
COMB combination	⊖B grab bar	PNT paint (ed)	TOL tolerance					Drainate
CONC concrete  CMU concrete masonry unit	GD grade. grading GVL grave;	PNL panel PB panic bar	T∉⊖ tongue and groove T O SLAB top of slab					Project:  O.M.B. / D.F.M.
M CONTR contract (or)	<b>⊝</b> T grout	PTD paper towel dispenser	TOS top of steel					THOMAS COLLINS BUILDING
CONST construction CONT continuous or continue	GPDW gypsum drywall	PTR paper towel receptor PAR parallel	TM top of wall TB towel bar					ELEVATOR UPGRADES
CLL contract limit line	HBD hardboard	PK parking	TRT treat (ed)					
CJT control joint CPR copper	HDM hardware HMD hardwood	PDB particle board PTN partition	TRANS transverse T tread					540 S. DUPONT HIGHWAY DOVER, DELAWARE 19901
CORR corrugated	HDR header	PV pave (d) (ing)	TYP typical					DOVER, DELAWARE 19901 STATE CONTRACT NO: MC1002000770
N CTR counter CFL counterflashing	HTG heating  HVAC heating/ventilation/air	PTMT pavement PERF perforate	UC undercut					Set No.: Sheet Title:  BID SET ARCHITECTURAL SYMBOLS,
CTSK countersunk screw	conditioning	PERI perimeter	UNF unfinished					ABBREVIATIONS & CODE DATA
CRS course (s)  CFT cubic feet	HD heavy duty HT height	PLAS plaster PLAM plastic laminate	UR urinal UNO unless noted otherwise					Proj.No.: O586BO45.BOI Scale: AS NOTED Sheet No.:
CYD cubic yard	HDPE high-density polyethelene	PL plate						Dwn.By: LMP Date: 6/5/23
O DPR damper	HC hollow core HM hollow metal	PG plate glass PMD plywood	∨B vapor barrier ∨ERT vertical					TO
		1 J ·	· · · · · · · · · · · · · · · · · ·					THIS DRAWING, THE DESIGN AND CONSTRUCTION FEATURES DISCLOSED ARE PROPRIETARY TO DAVIS, BOWEN & FRIEDEL, INC., AND SHALL NOT BE ALTERED OR REUSED WITHOUT WRITTEN PERMISSION.
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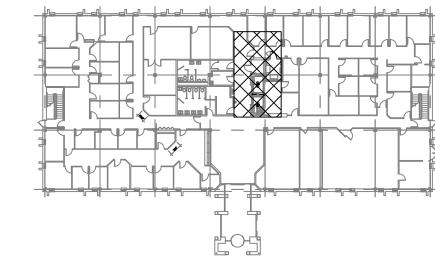
#### **NEW WORK NOTES**

- INSTALL NEW BRANCH LINE WITH SUPERVISED VALVE DOWN TO WITHIN 24" OF HOIST WAY FLOOR.
- 2 EXISTING ELEVATOR MACHINE ROOM SUPERVISED VALVE.

#### LEGEND/ ABREVIATIONS

PENDANT SPRINKLER HEAD

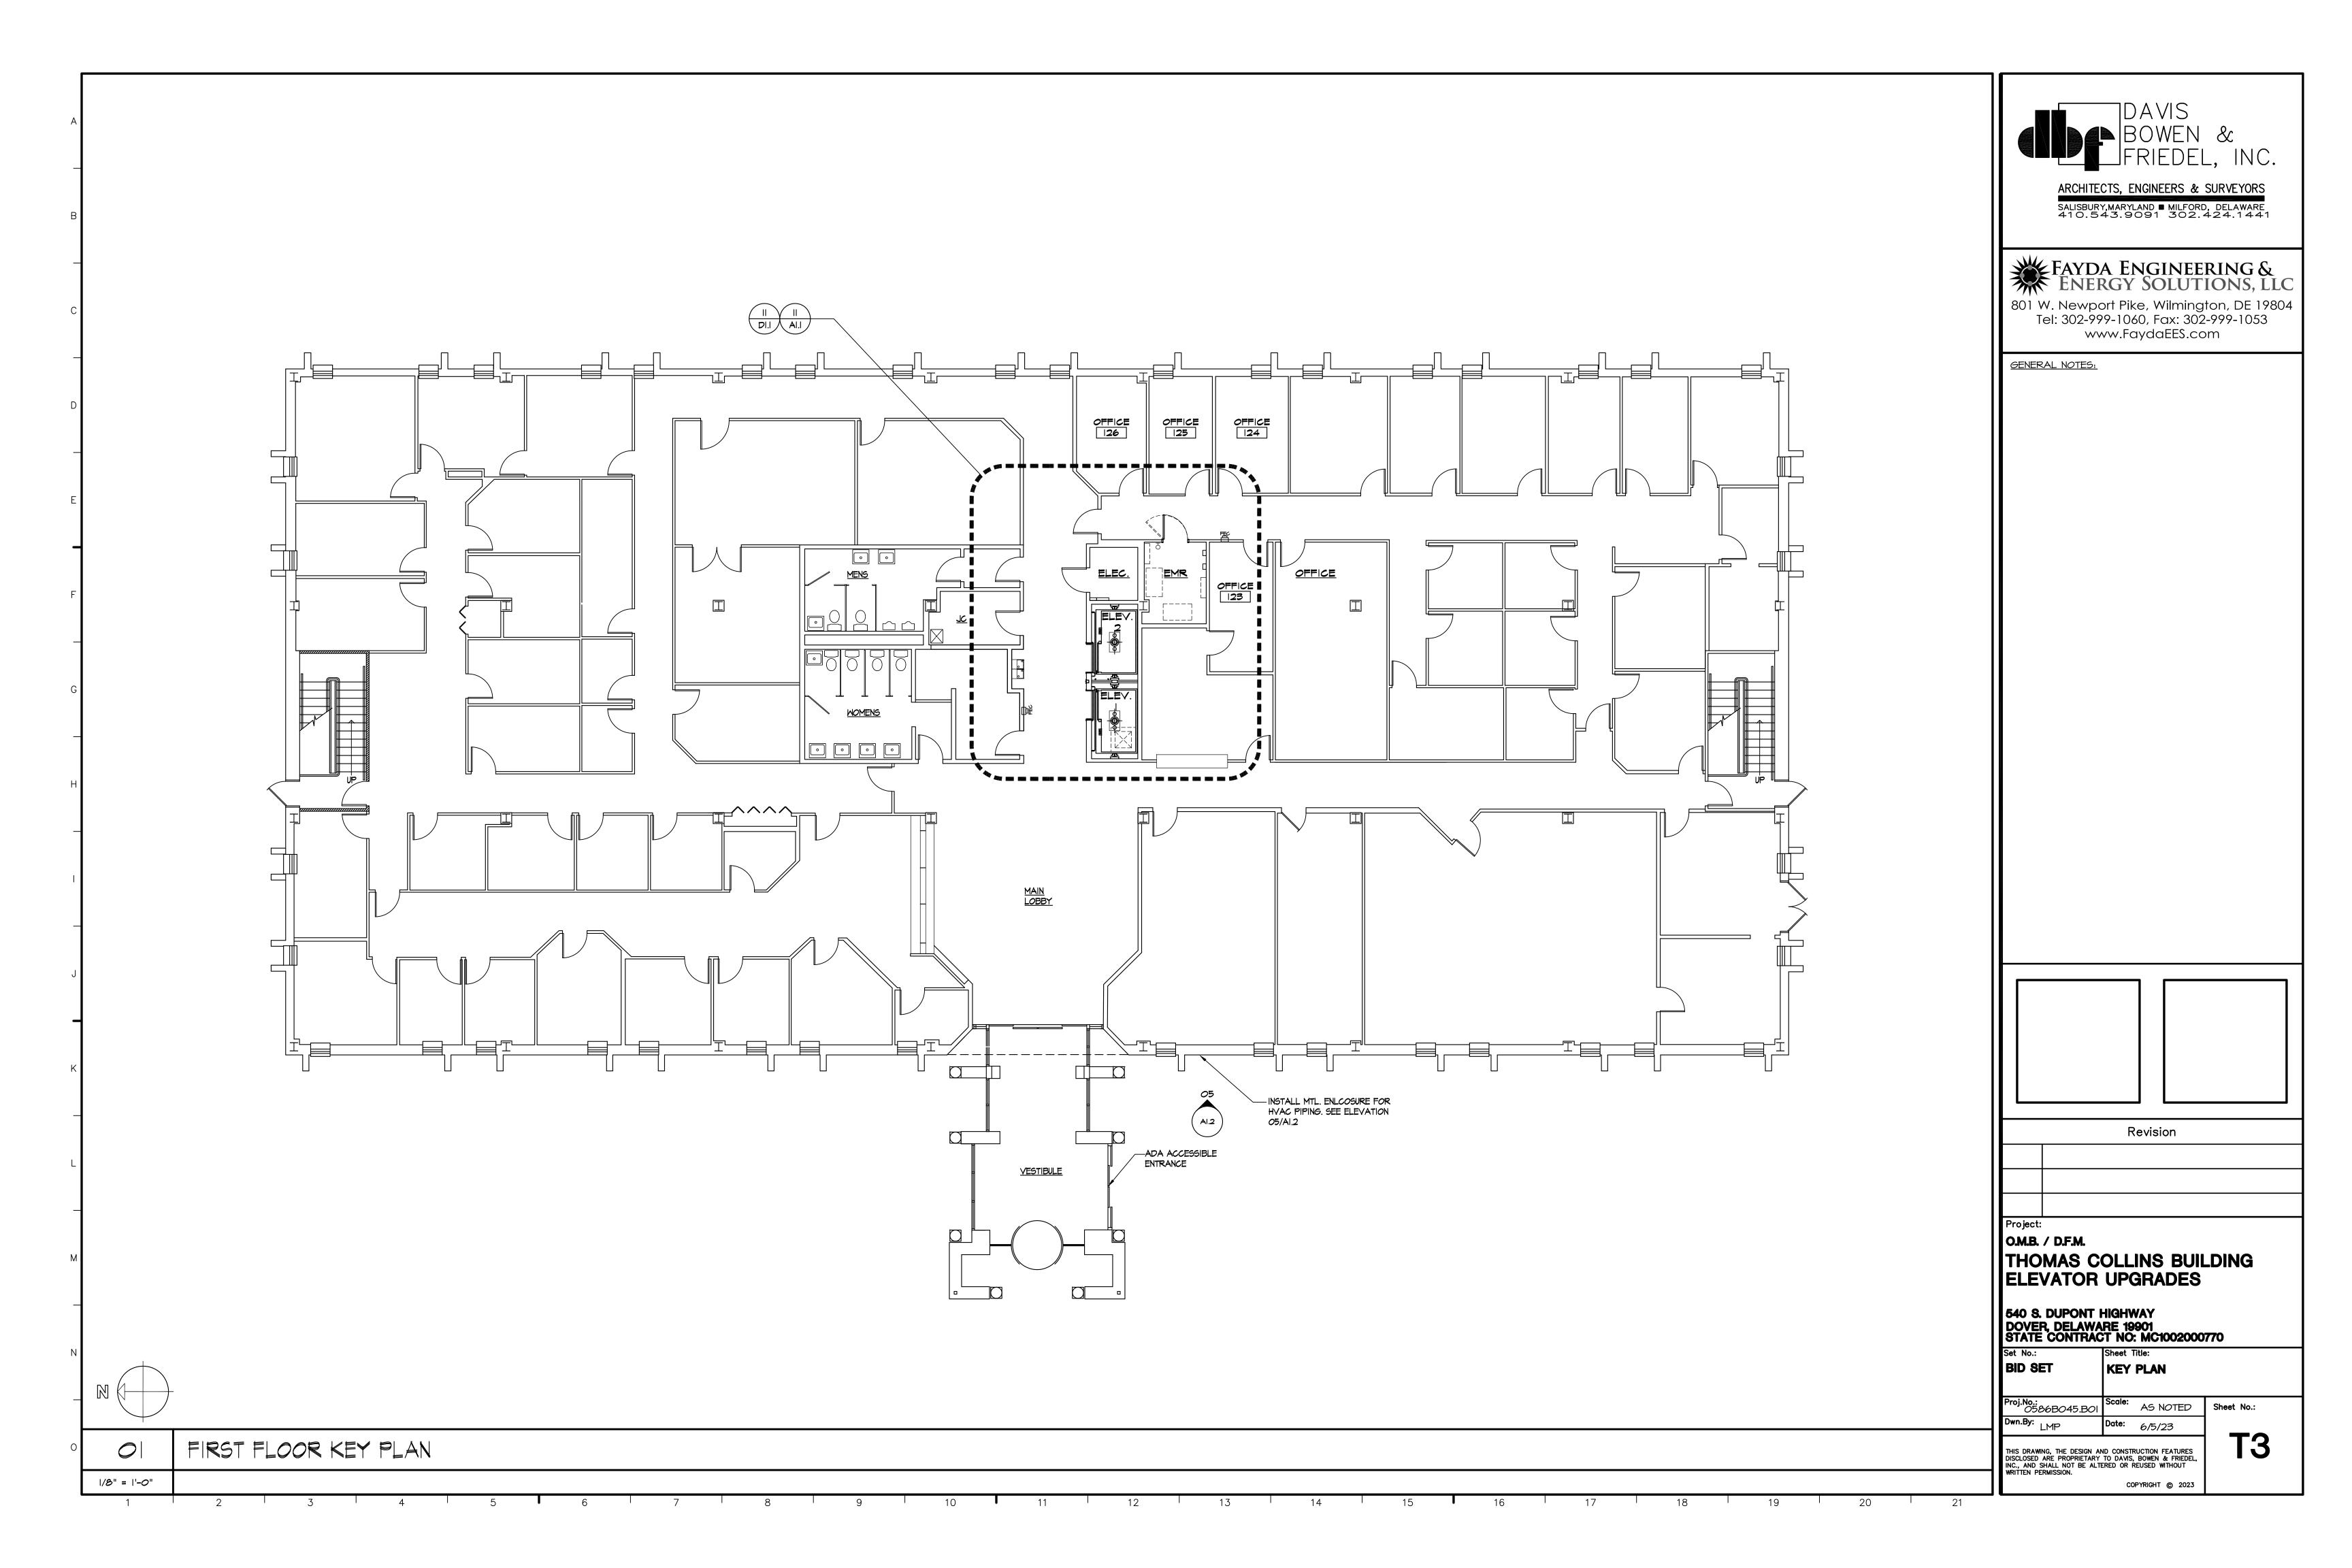UPRIGHT SPRINKLER HEAD

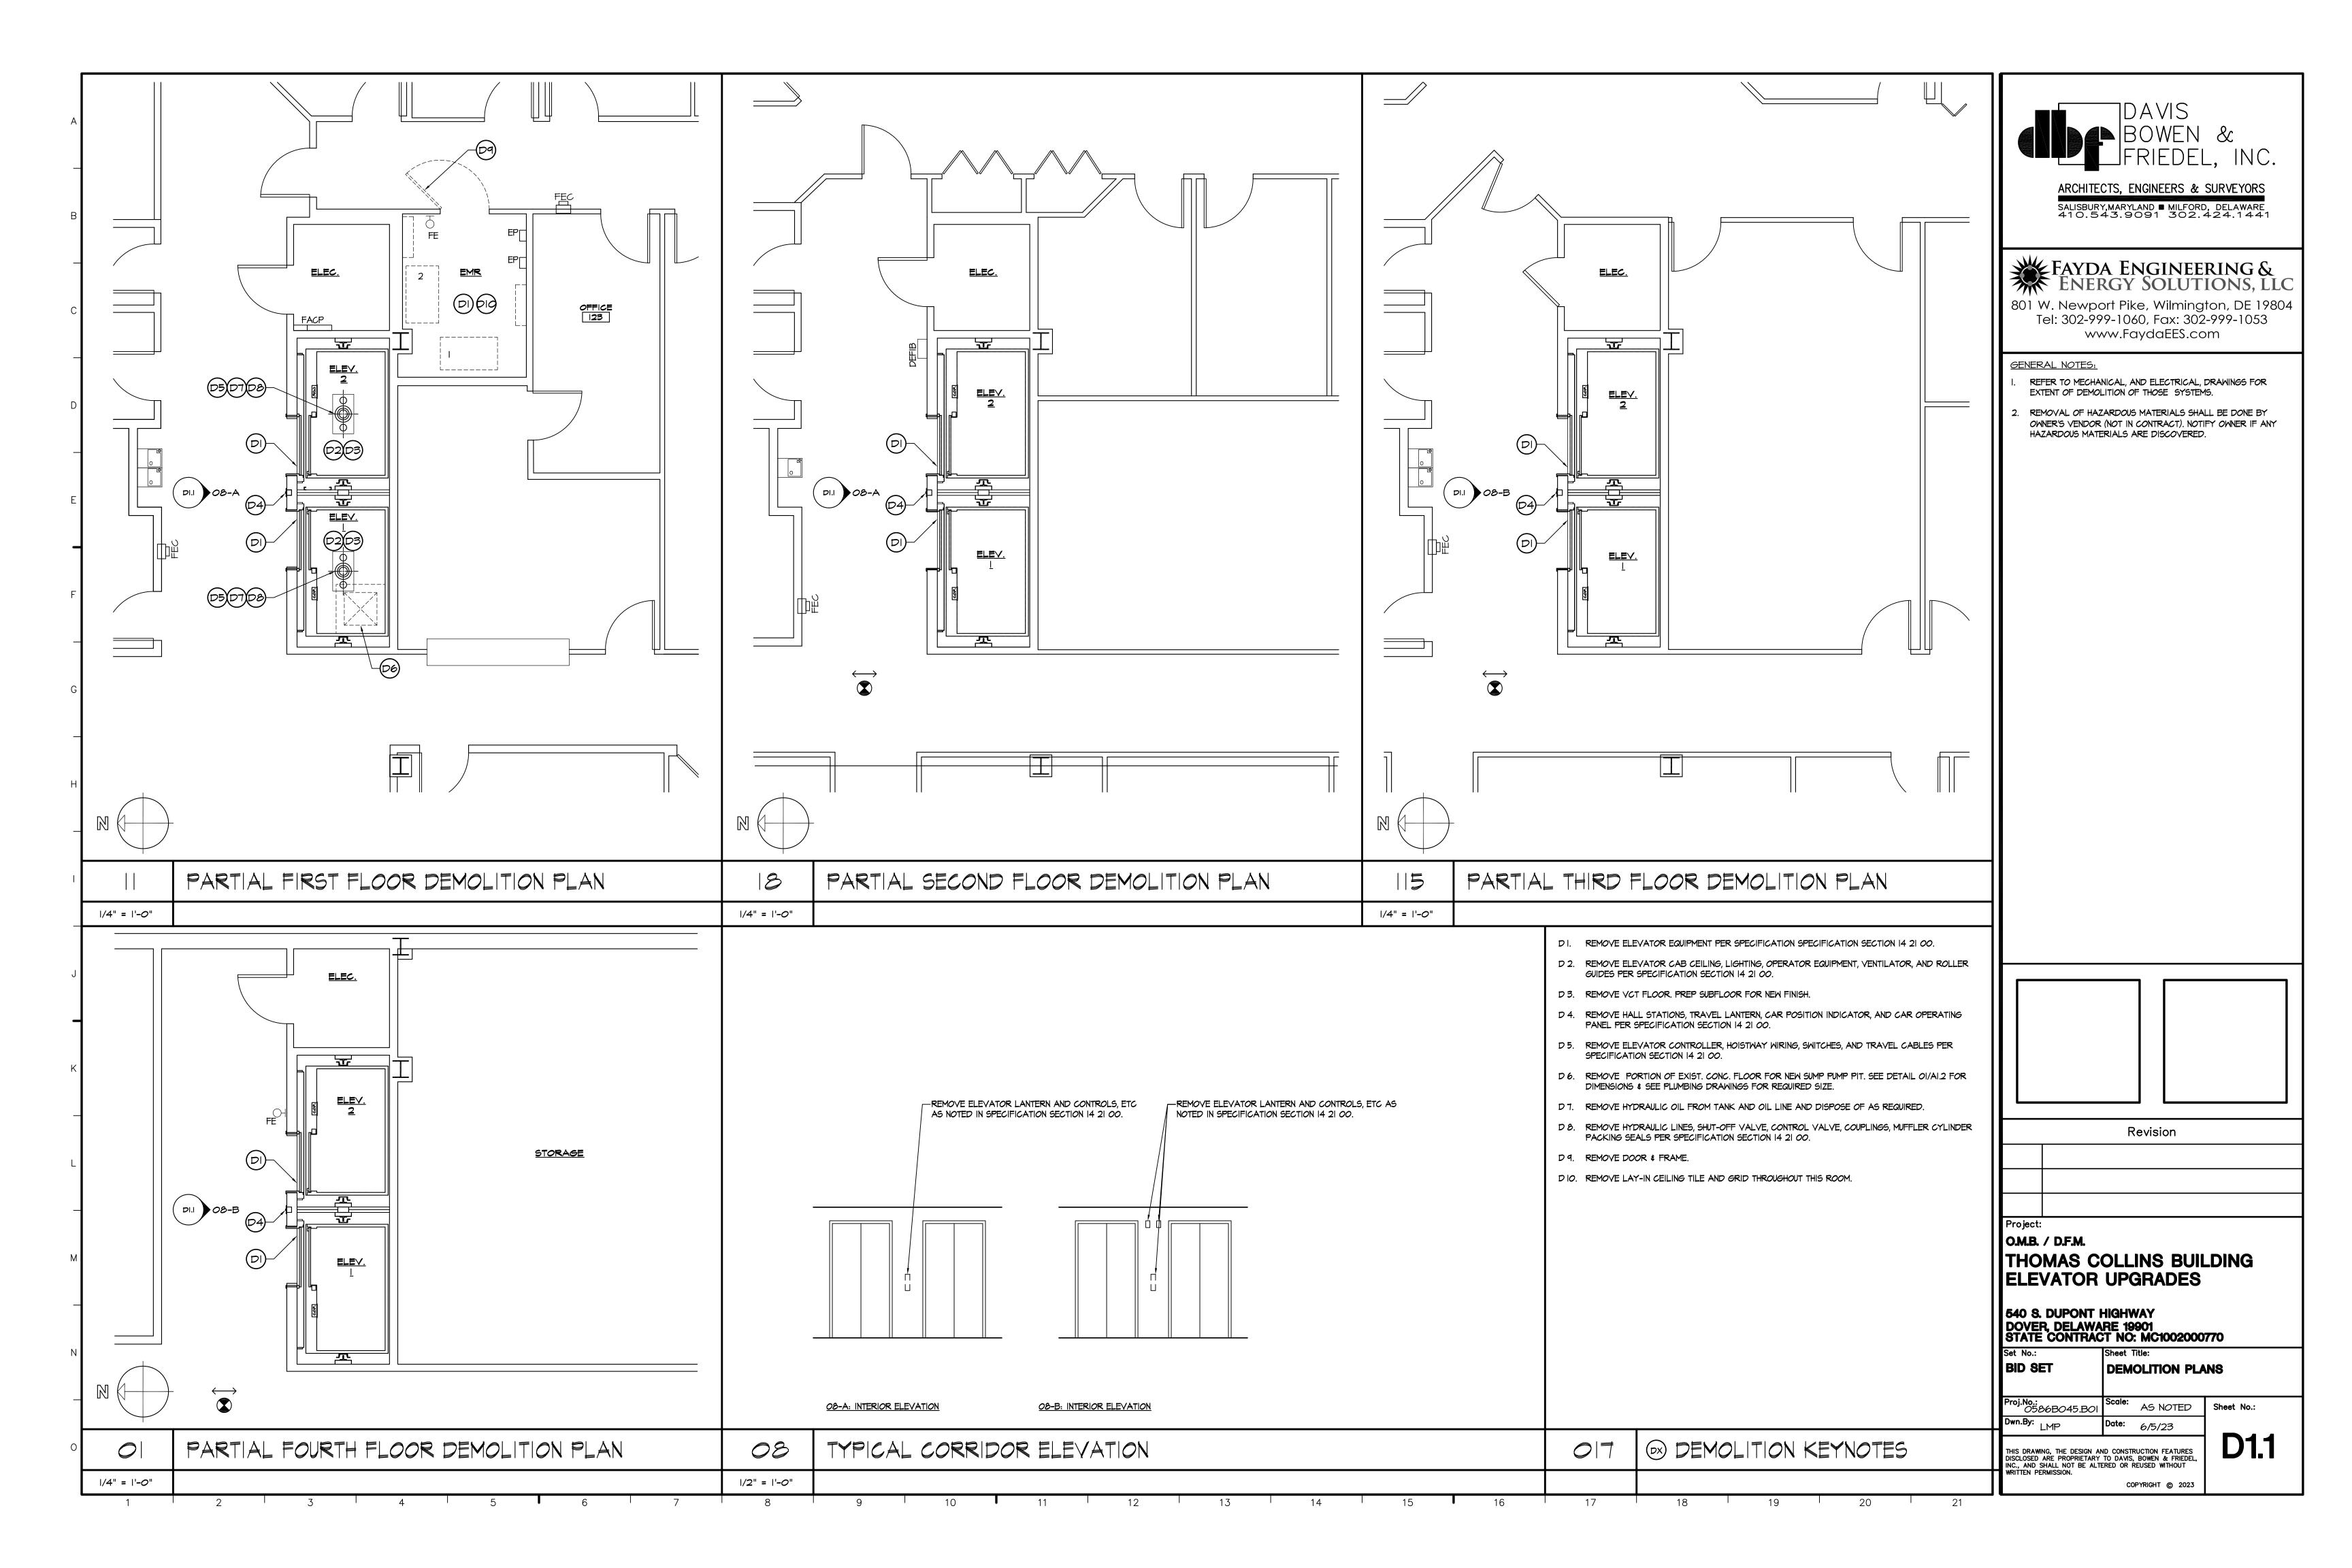

KEY PLAN SCALE: NTS




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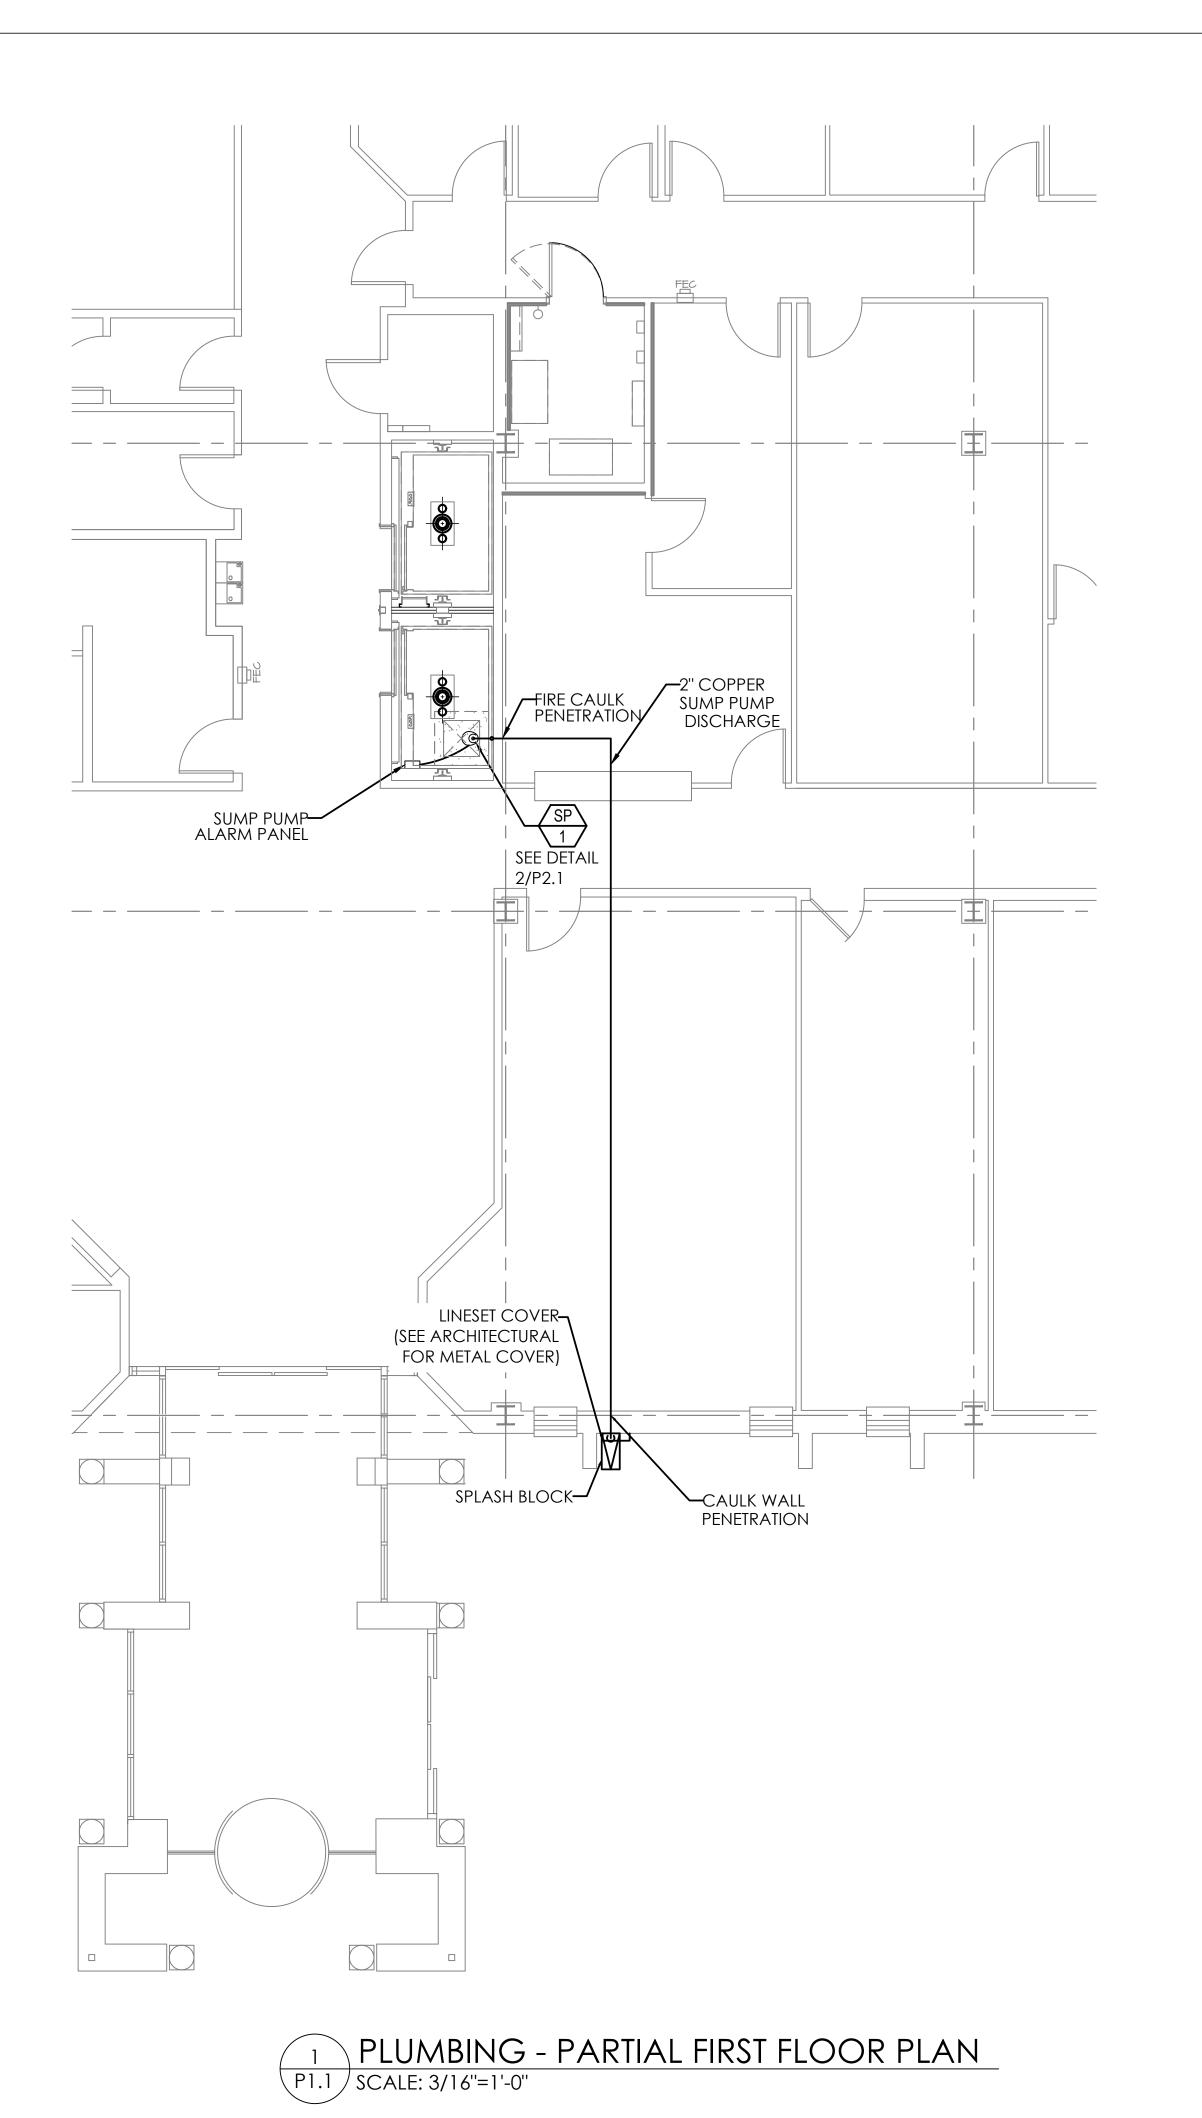
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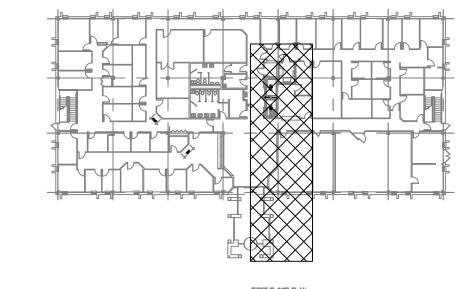
THOMAS COLLINS BUILDING **ELEVATOR UPGRADES** 

540 S. DUPONT HIGHWAY DOVER, DELAWARE 19901 STATE CONTRACT NO: MC1002000770

Sheet Title:
FIRE PROTECTION-PARTIAL BID SET FIRST FLOOR PLAN Proj.No.: 0586B045.B01 Scale: AS NOTED | Sheet No.:

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KEY PLAN SCALE: NTS

#### LEGEND ABBREVIATION DESCRIPTION

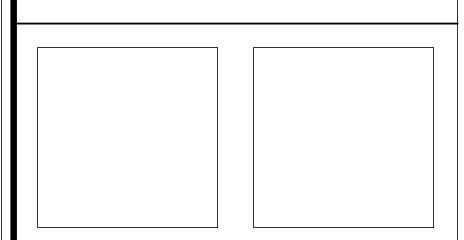SUMP PUMP PIPING DOWN PIPING UP



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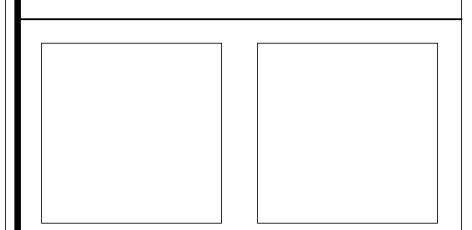
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PLUMBING - PARTIAL BID SET FIRST FLOOR PLAN Proj.No.: *0586*B045.B01 Scale: AS NOTED | Sheet No.:


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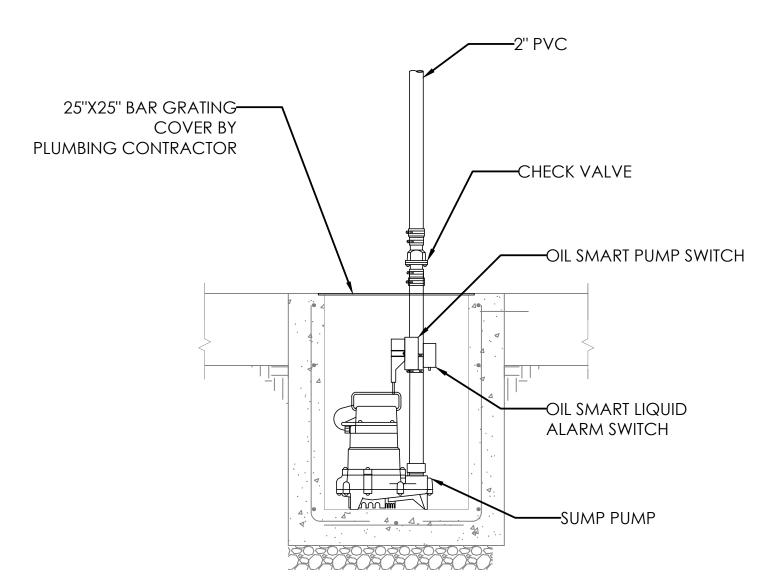
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	PLUMBING FIXTURE SCHEDULE									
TAG	ITEM	MODEL	MFGR	VOLTAGE	HP	AMPS	REMARKS			
SP-1	SUMP PUMP	161	ZOELLER	115-1-60	1/2	15	OIL GUARD PREPACKAGED SYSTEM (940- 0014) WITH ALARM PANEL, OIL SWITCH, AND PUMP			

#### GENERAL PLUMBING NOTES:

- ALL WORK SHALL BE PERFORMED PER THE 2009 INTERNATIONAL PLUMBING CODE.
- CONTRACTOR SHALL PROVIDE ALL LIFTS/SCFFOLDING TO PERFORM THEIR WORK.
- SECURELY SECURE ALL NEW PIPING TO THE EXISTING STRUCTURE.
- COORDINATE INSTALLATION OF PIPING WITH OTHER TRADES.
- CORE DRILL ALL HOLES THROUGH EXISTING CONCRETE WALLS. SEAL ALL PENETRATIONS WITH 2-HOUR FIRE CAULK.
- FIRESTOP ALL PENETRATIONS.
- REFER TO SPECIFICATIONS FOR ADDITIONAL INFORMATION AND REQUIREMENTS.





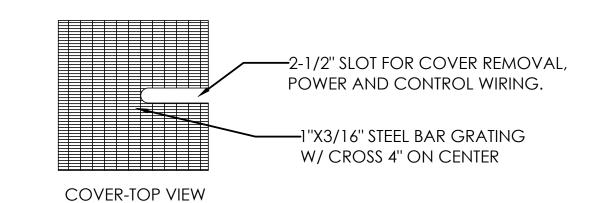


#### CONTRACTOR SHALL CONNECT THE NEW SUMP PUMP ALARM PANEL AND OIL MINDER TO THE EXISTING

SUMP PUMP ALARM PANEL NOTES:

- AUTOMATED LOGIC BUILDING AUTOMATION SYSTEM (BY RADIUS SYSTEMS).
- 2. PROVIDE ALARMS LOCALLY AT THE OPERATOR'S WORKSTATION AND GENERATE EMAIL/TEXT ALARMS TO FACILITIES PERSONNEL FOR THE FOLLOWING POINTS:
- WATER PRESENT

PUMP IN ALARM

OIL PRESENT

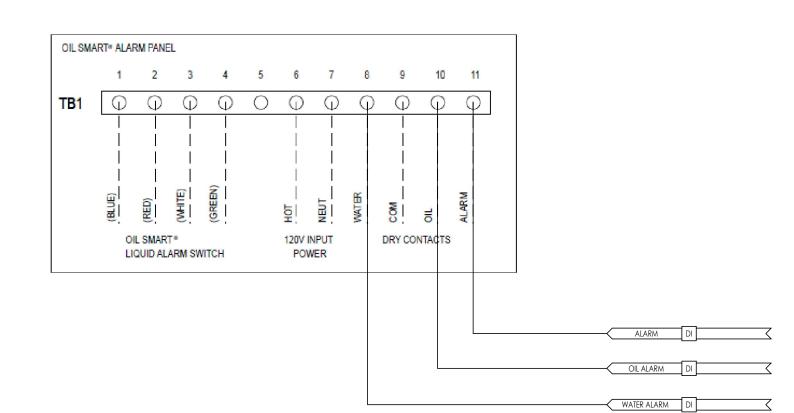






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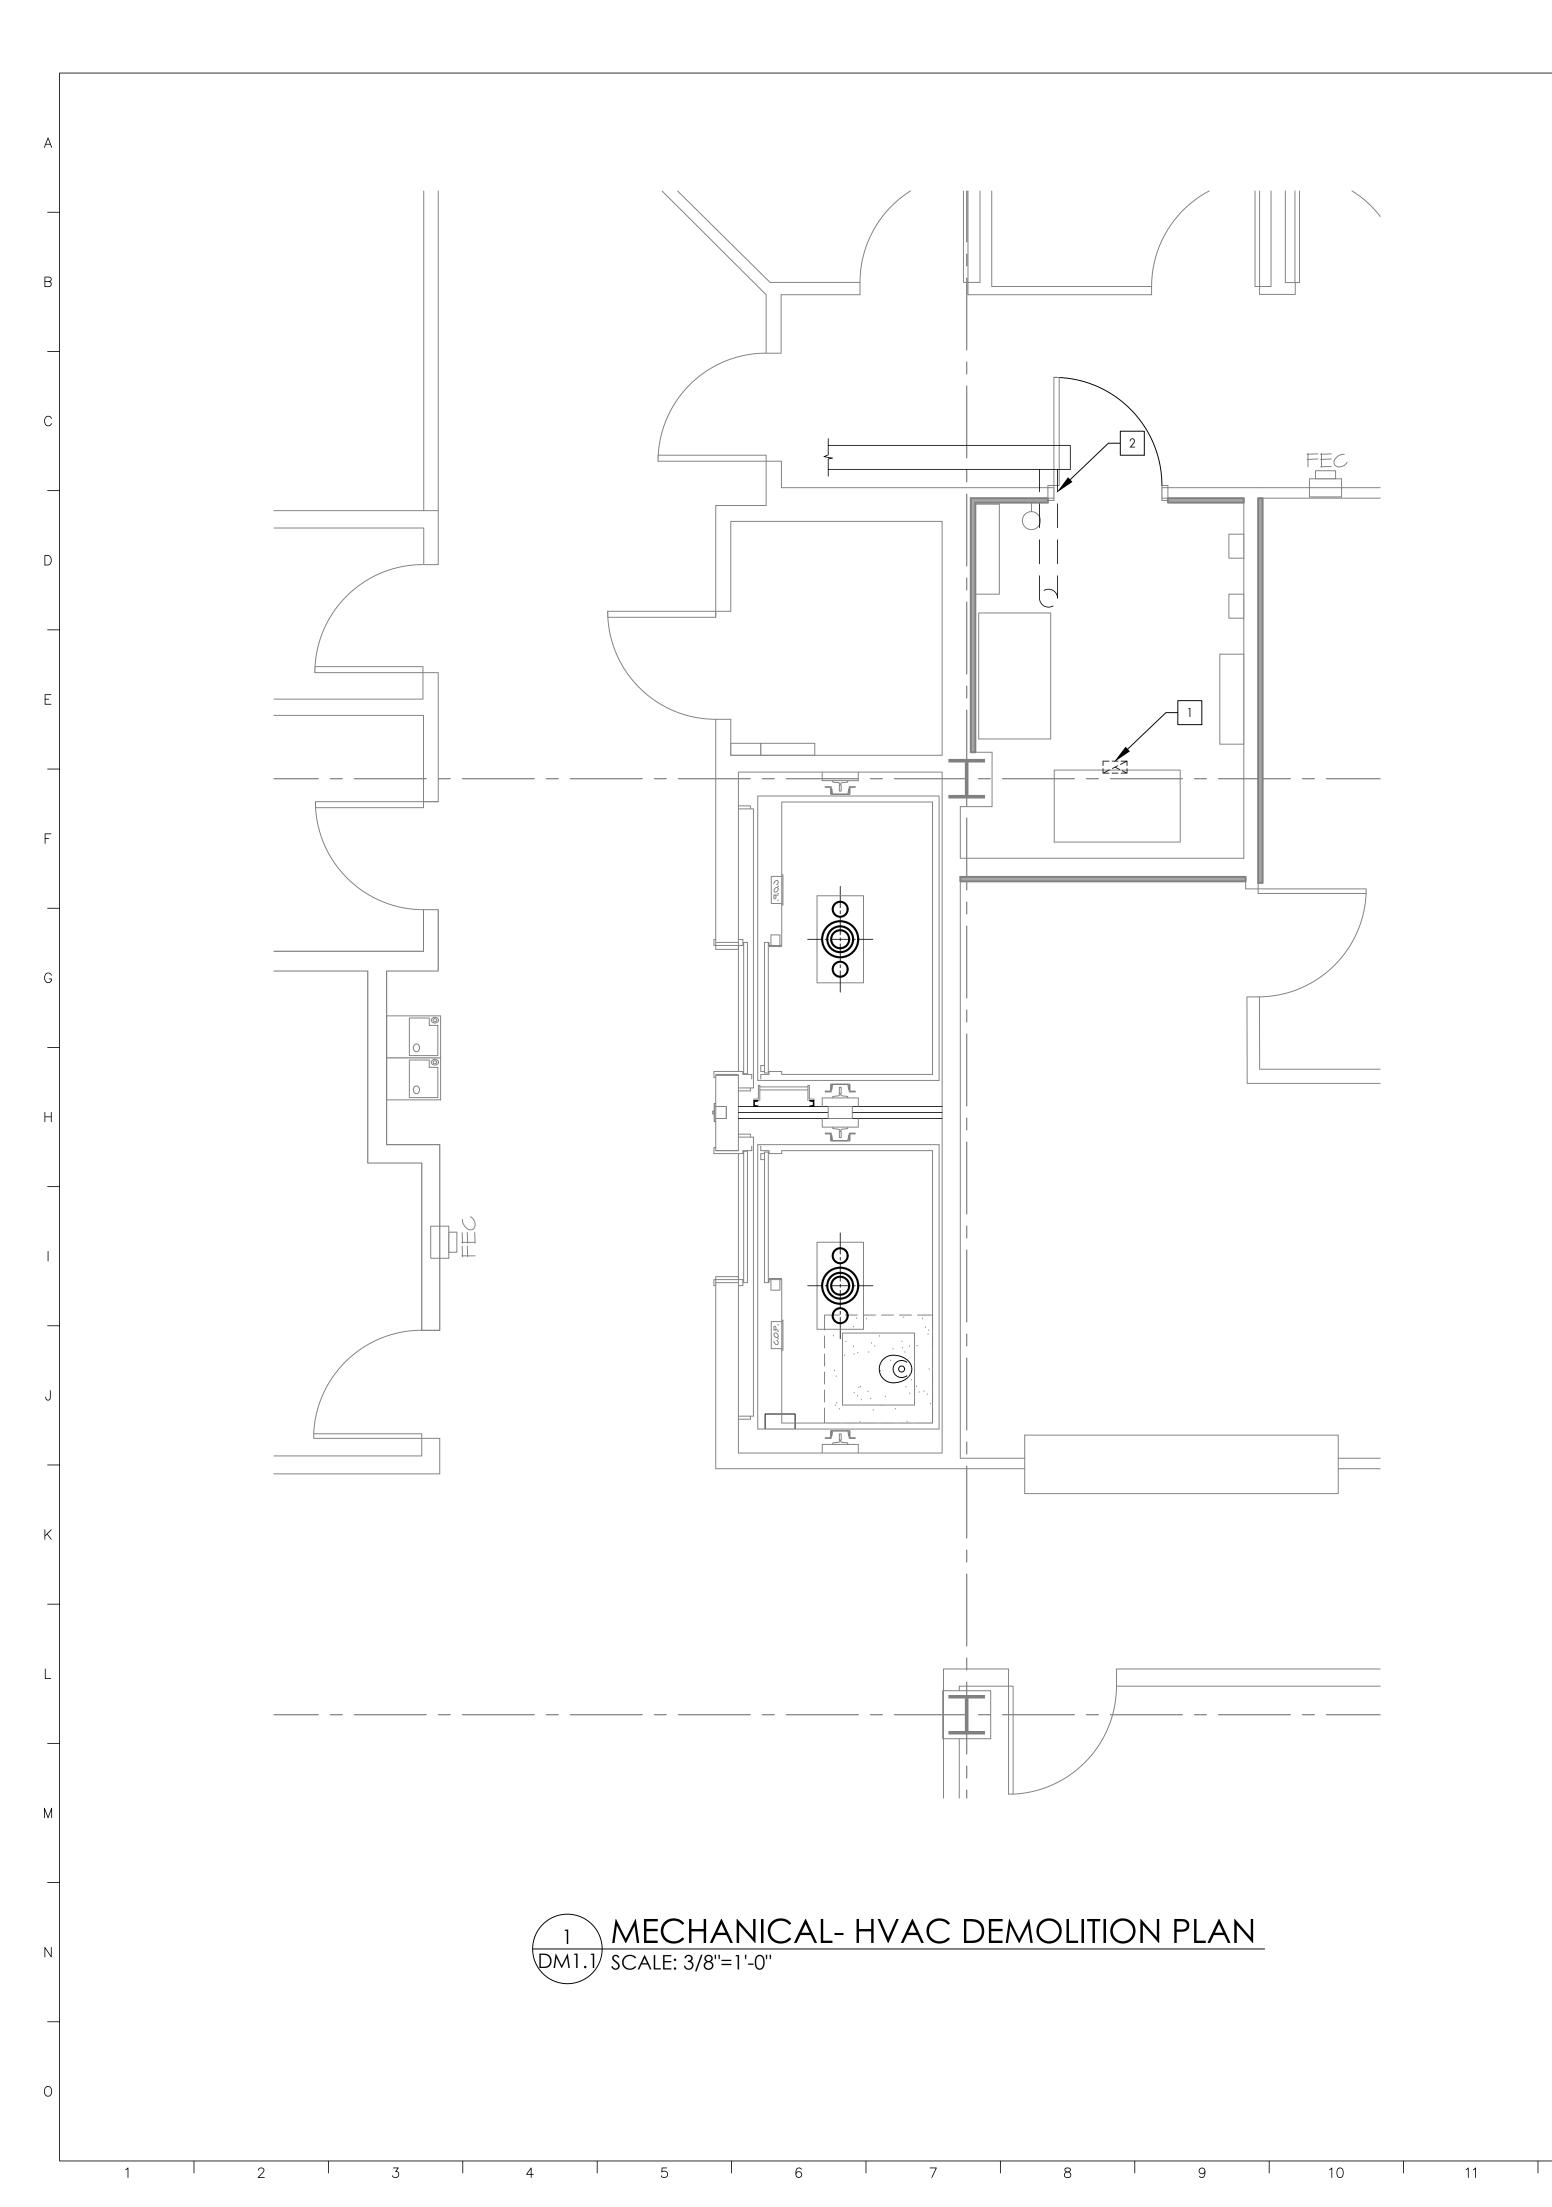


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BID SET PLUMBING - SCHEDULES & NOTES cale: AS NOTED Proj.No.: 0586B045.B01 Sheet No.:


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#### **DEMOLITION WORK NOTES**

REMOVE EXISTING PLENUM RETURN GRILLE.

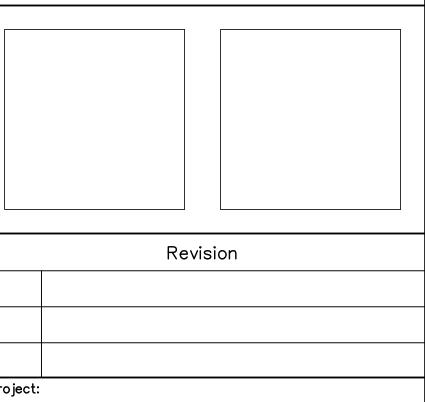2 REMOVE EXISTING 6" FLEX DUCT AND CAP EXISTING DUCT.



KEY PLAN
SCALE: NTS

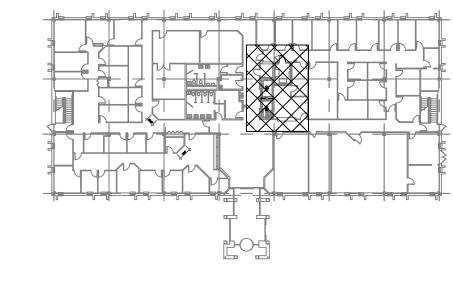

ARCHITECTS, ENGINEERS & SURVEYORS

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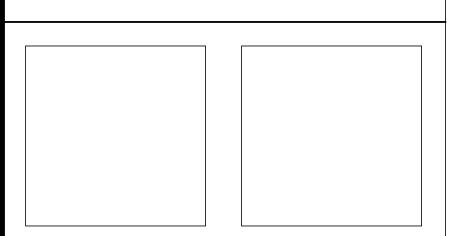
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Set No.:

BID SET

MECHANICAL - HVAC
DEMOLITION PLAN

Proj.No.:

0586B045.B01

Scale:

AS NOTED

Sheet No.:

Dwn Bv:

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14 15 16 17 18 19 20

VRF INDOOR UNIT SCHEDULE Max Fan ESP Refrig Pipe Dim Cooling Design | Heating Design | Cooling Diversity | Heating Diversity Estimated Setting Estimated Condensate Nominal Cooling Nominal Heating | Entering Temp | Entering Temp | Full/Partial (See | Cooling Total | Cooling Sensible | Full/Partial (See | Heating Capacity | Cooling Coil LAT | Heating Coil LAT | Liquid/Suction Fan Speed Peak Fan Airflow | 208V/230V (IN Electrical Removal Rate System Tag | Tag Reference | M-NET Address | Mitsubishi Model | Capacity (BTU/h) DB/WB (°F) DB/WB (°F) Note 5, 6) Capacity (BTU/h) Capacity (BTU/h) Note 5, 6) MCA/MFS Capacity (BTU/h) (°F) WG) (gal/hr) Notes / Options Ceiling-0.14/0.20/0.28/0. | 208/230V/1-Concealed Powered by 19,000.0 PEAD-A18AA7 (Ducted) 75.0/63.0 FULL DEMAND | 15,657.7 12,947.0 FULL DEMAND 00.0 1/2 / 1/4 1, 2, 3, 4, 5, 6 Outdoor

Notes & Options:

1 Nominal cooling capacities are based on indoor coil EAT of 80/67°F (DB/WB), outdoor of 95°F (DB)

2 Nominal heating capacities are based on indoor coil EAT of 70°F (DB), outdoor of 43°F (WB)

3 See outdoor unit schedule for outdoor ambient conditions, connected capacity, and other factors associated with corrected capacities

4 See schematic piping/control diagram for indication of required indoor unit remote controllers, system controllers, and integration

5 Full demand corrected capacity includes de-rate associated with indoor vs. outdoor connected capacity indicated on outdoor unit

schedule for associated system.

Partial corrected capacity assumes sufficient diversity exists such that the connected capacity de-rate does not apply. It is the designer's responsibility to ensure "Diamond System Builder" is set in the appropriate output capacity setting (full

RD-12<del>-</del>

PUMPED

CONDENSATE

FIRE DAMPER

—12"Ø 1-1/2 HOUR FIRE DAMPER

**/**−1/4" LIQUID 1/2" SUCTION

demand/partial demand) prior to generating this schedule 6 It is recommended to always base heating corrected capacity on full demand.

MITSUBISHI ELECTRIC TRANE HVAC US: CITY MULTI VRF OUTDOOR UNIT SCHEDULE

				Cooling		Nom System										
				Efficiency		Connected	Design Cooling	Design Heating	Max Pipe Length	Corrected	Corrected		Electrical-	Per Module		
		Nominal Cooling	Nominal Heating	IEER/EER	Heating COP @	Capacity (% of	Outdoor Temp	Outdoor Temp	from BC or 1st	Cooling Total	Heating Capacity		208/230	or [460V]		
System Tag	Tag Reference	Model Number   Capacity (BTU/h)	Capacity (BTU/h)	[SEER]	47°F [HSPF]	NOM)	DB (°F)	WB (°F)	Joint (feet)	Capacity (BTU/h)	(BTU/h)	Voltage / Phase	MCA 208/230	RFS	MOCP	Notes / Options
												208/230V / 1-				
System 1	CU-1	PUY-A18NKA7 18,000.0	00.0	0 [19.90]	0 [Clg Only]	100.0%	92.0	8.9	0.0	15,657.7	00.0	phase	11	15	28	1, 2, 3, 4, 5

Notes & Options:

1 Nominal cooling capacities are based on indoor coil EAT of 80/67°F (DB/WB), outdoor of 95°F (DB)


2 Nominal heating capacities are based on indoor coil EAT of 70°F (DB), outdoor of 43°F (WB) 3 Efficiency values for EER, IEER, COP are based on AHRI 1230 test method for mixture of ducted & non-

4 For systems with multiple modules, refrigerant pipe dimensions indicate total system combined piping 5 Added field charge listed is in addition to factory charge, this must be updated based upon final as-built

#### GENERAL MECHANICAL NOTES:

- 1. ALL WORK SHALL BE PERFORMED PER THE 2009 INTERNATIONAL MECHANICAL CODE AND 2018
- INTERNATIONAL ENERGY CONSERVATION CODE.
- CONTRACTOR SHALL PROVIDE ALL LIFTS/SCAFFOLDING TO PERFORM THEIR WORK.
- FIRESTOP ALL PENETRATIONS.
- REFER TO SPECIFICATIONS FOR ADDITIONAL INFORMATION AND REQUIREMENTS.
- PROVIDE 1" HIGH DRAIN PAN UNDER ENTIRE IDU-1 WITH WATER SENSOR TO DISABLE COOLING WHEN WATER
- IS DETECTED IN THE DRAIN PAN.
- REFER THE PLUMBING DRAWINGS FOR BAS MONITORING OF THE NEW ELEVATOR SUMP PUMP SYSTEM.


		G	RD S	CHEDULE			
TAG	TYPE	NECK	FA CE	MATERIAL	COLOR	MFGR	MODEL
SD-12	3-STEP CONE	12''Ø	24X24	A LUMINUM	WHITE	TUTTLE & BAILEY	A 1300
RD-12	PERFORATED RETURN	12''Ø	24X24	A LUMINUM	WHITE	TUTTLE & BAILEY	APR

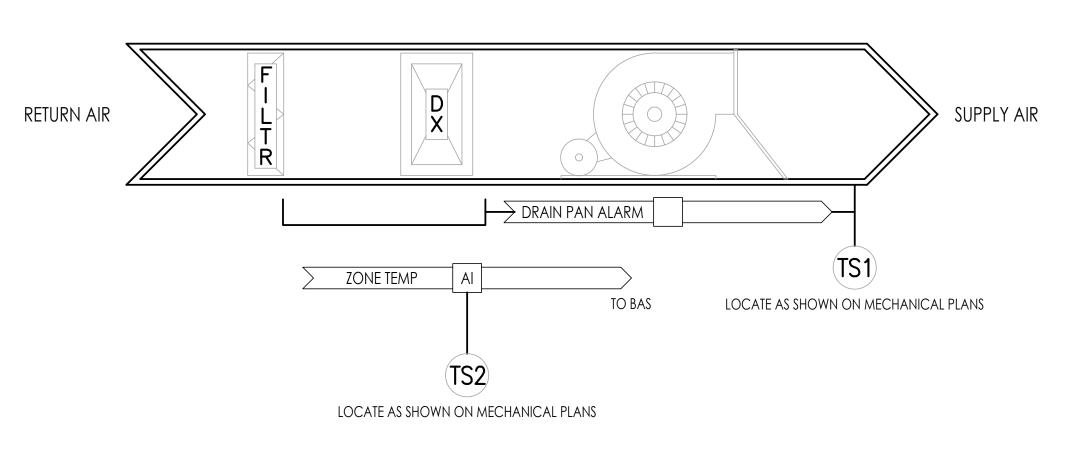



#### CONTROL NOTES:

- BAS SHALL MONITOR THE SPACE TEMPERATURE IN THE ELEVATOR MACHINE ROOM. ALARM ABOVE 80 DEG F.
- Drain Pan Sensor Shall Shut System Down in THE EVENT WATER IS DETECTED IN THE DRAIN PAN.
- UNIT SHALL OPERATE BASED UPON ITS STAND ALONE CONTROLS.

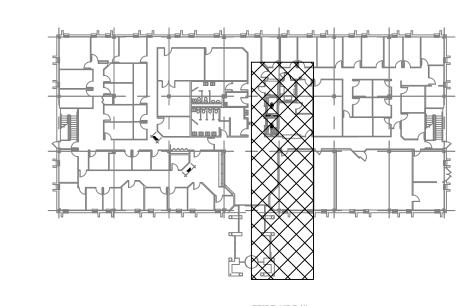

KEY PLAN SCALE: NTS




ARCHITECTS, ENGINEERS & SURVEYORS

## FAYDA ENGINEERING & ENERGY SOLUTIONS, LLC

801 W. Newport Pike, Wilmington, DE 19804 Tel: 302-999-1060, Fax: 302-999-1053 www.FaydaEES.com



106 West Commerce Street Smyrna, DE 19977 Tel: 302-659-9090

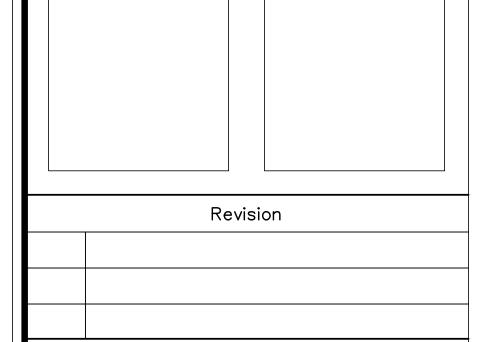


O.M.B. / D.F.M.

THOMAS COLLINS BUILDING **ELEVATOR UPGRADES** 

540 S. DUPONT HIGHWAY DOVER, DELAWARE 19901 STATE CONTRACT NO: MC1002000770


**MECHANICAL - HVAC** BID SET PLAN OJ.NO.: 0586B045.B01 AS NOTED


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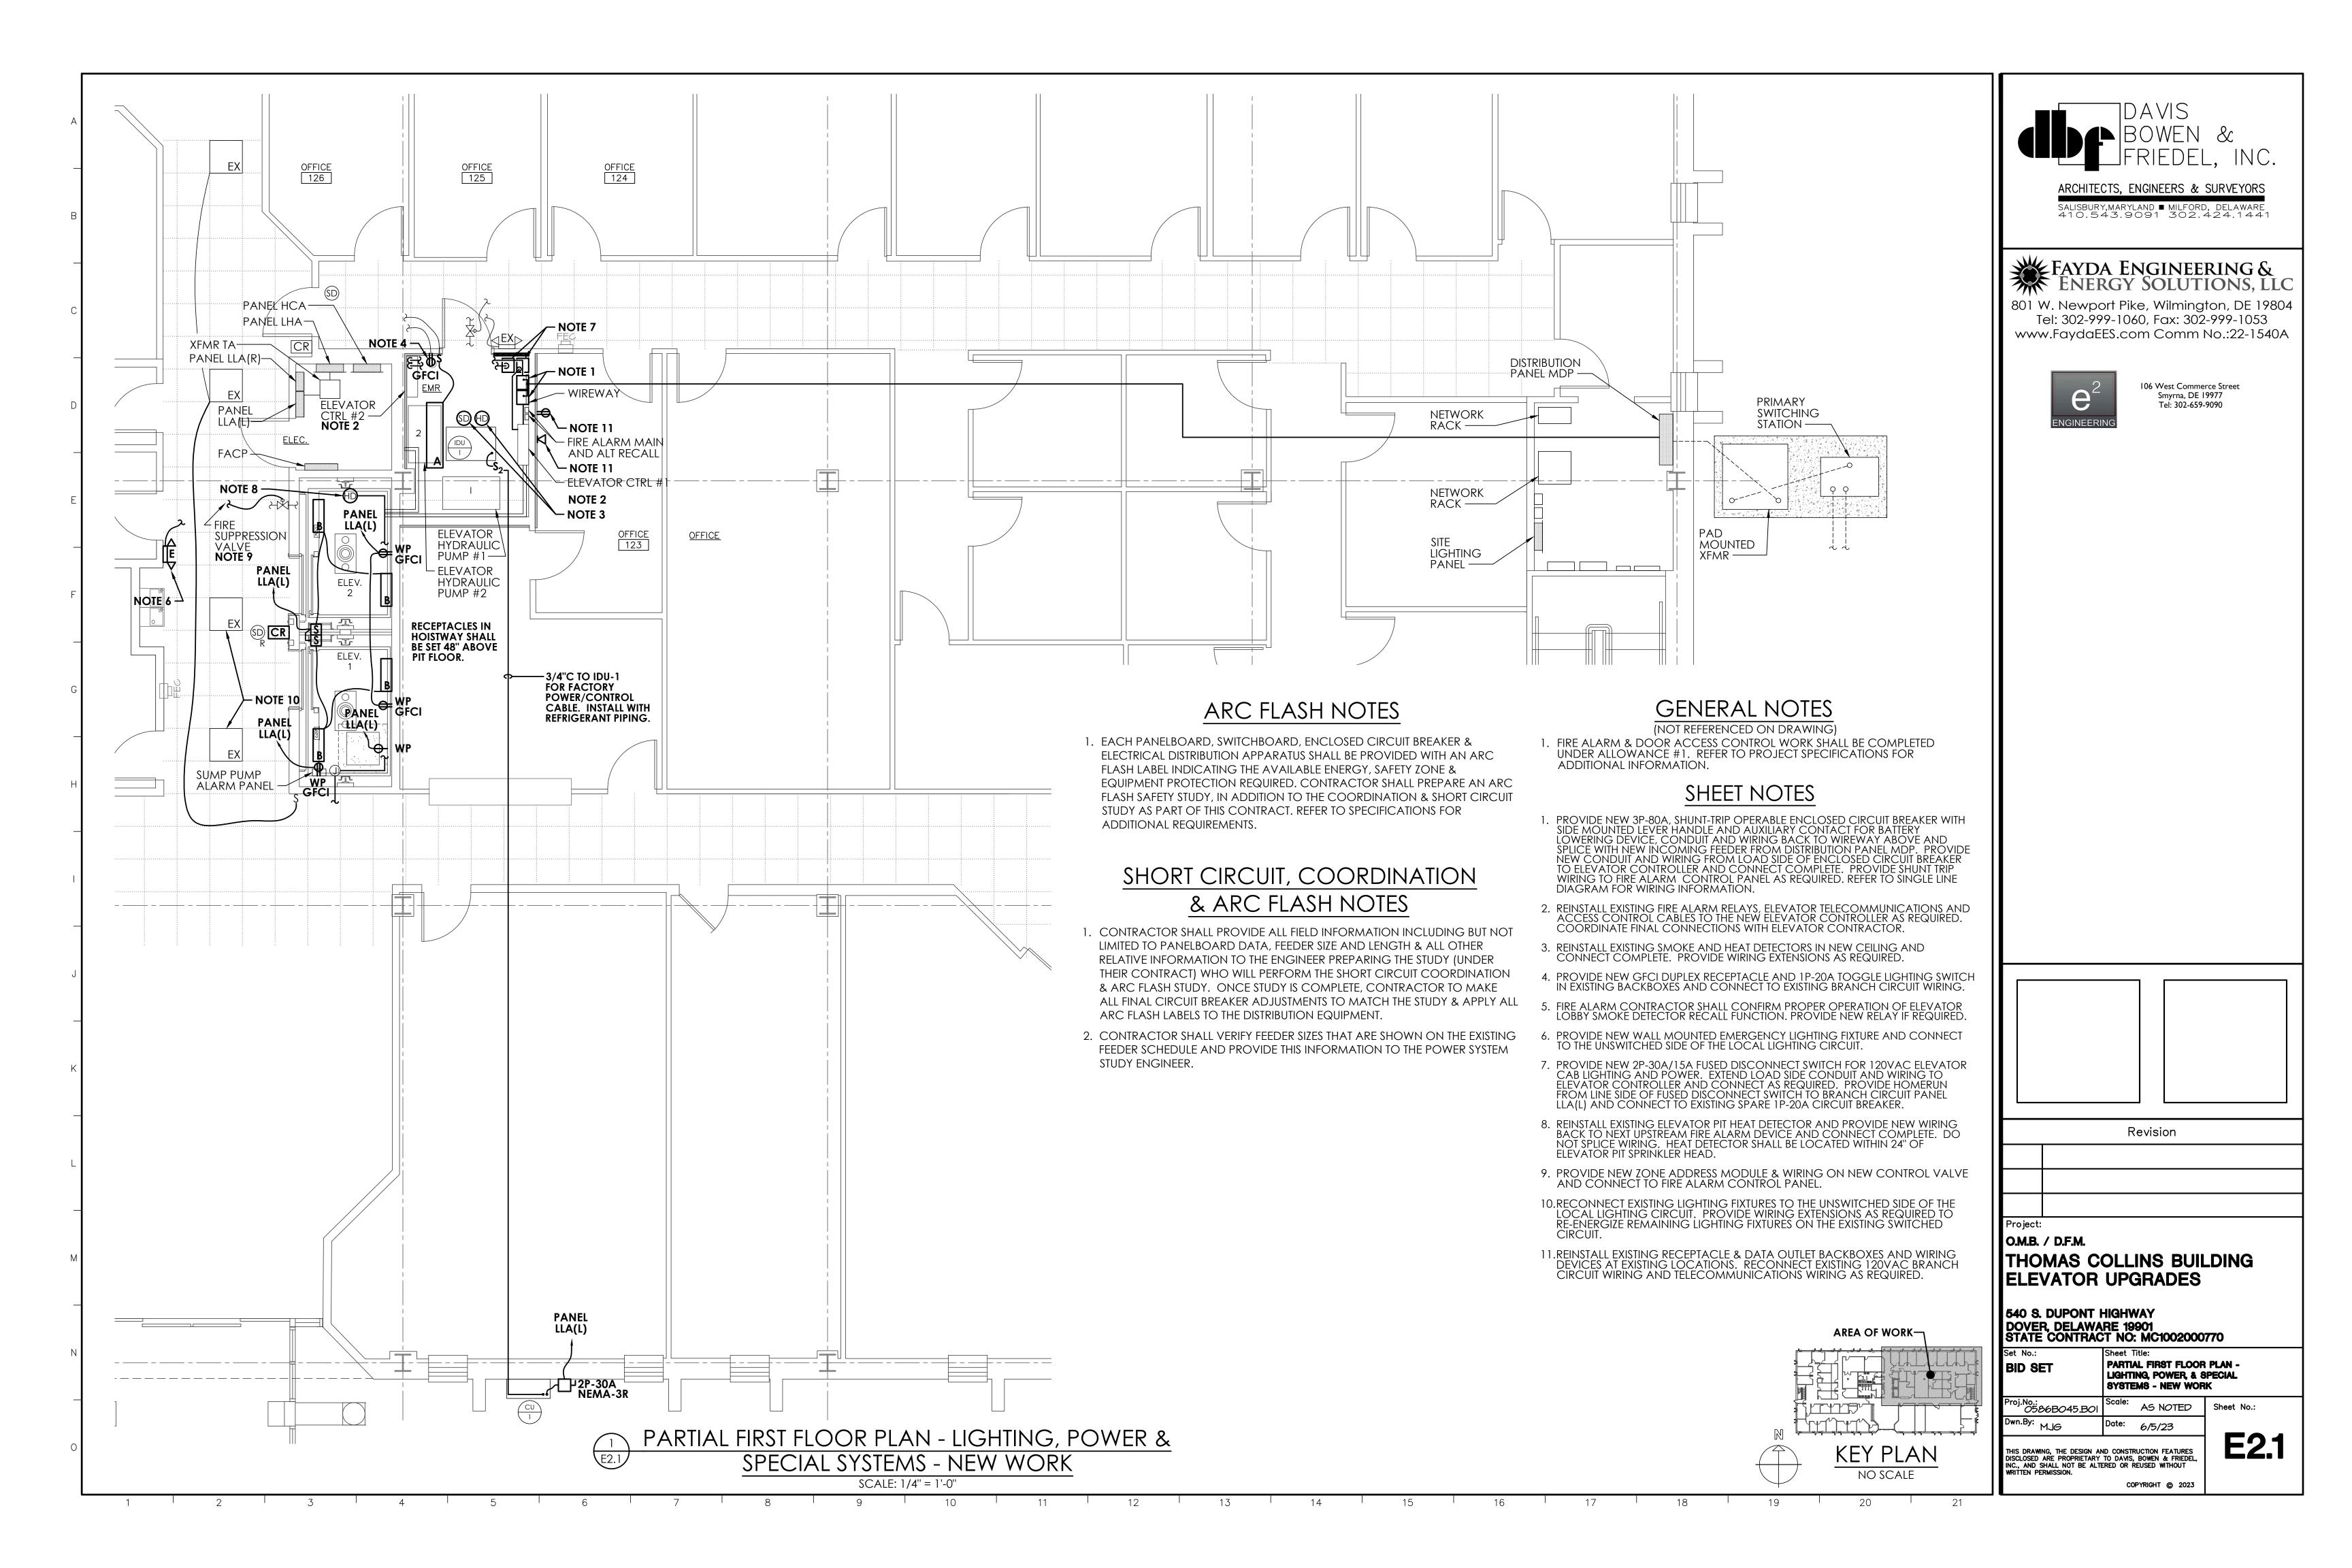


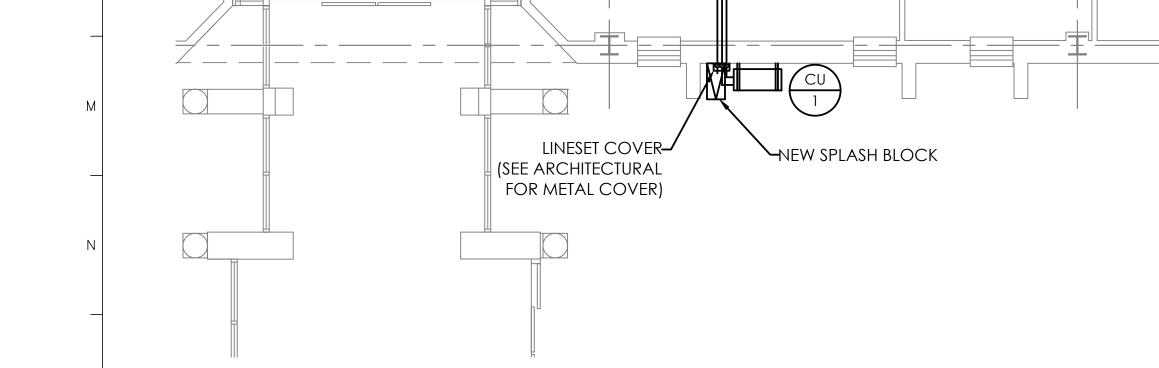
M1.1 SCALE: 3/16"=1'-0"

MECHANICAL- FIRST FLOOR PLAN



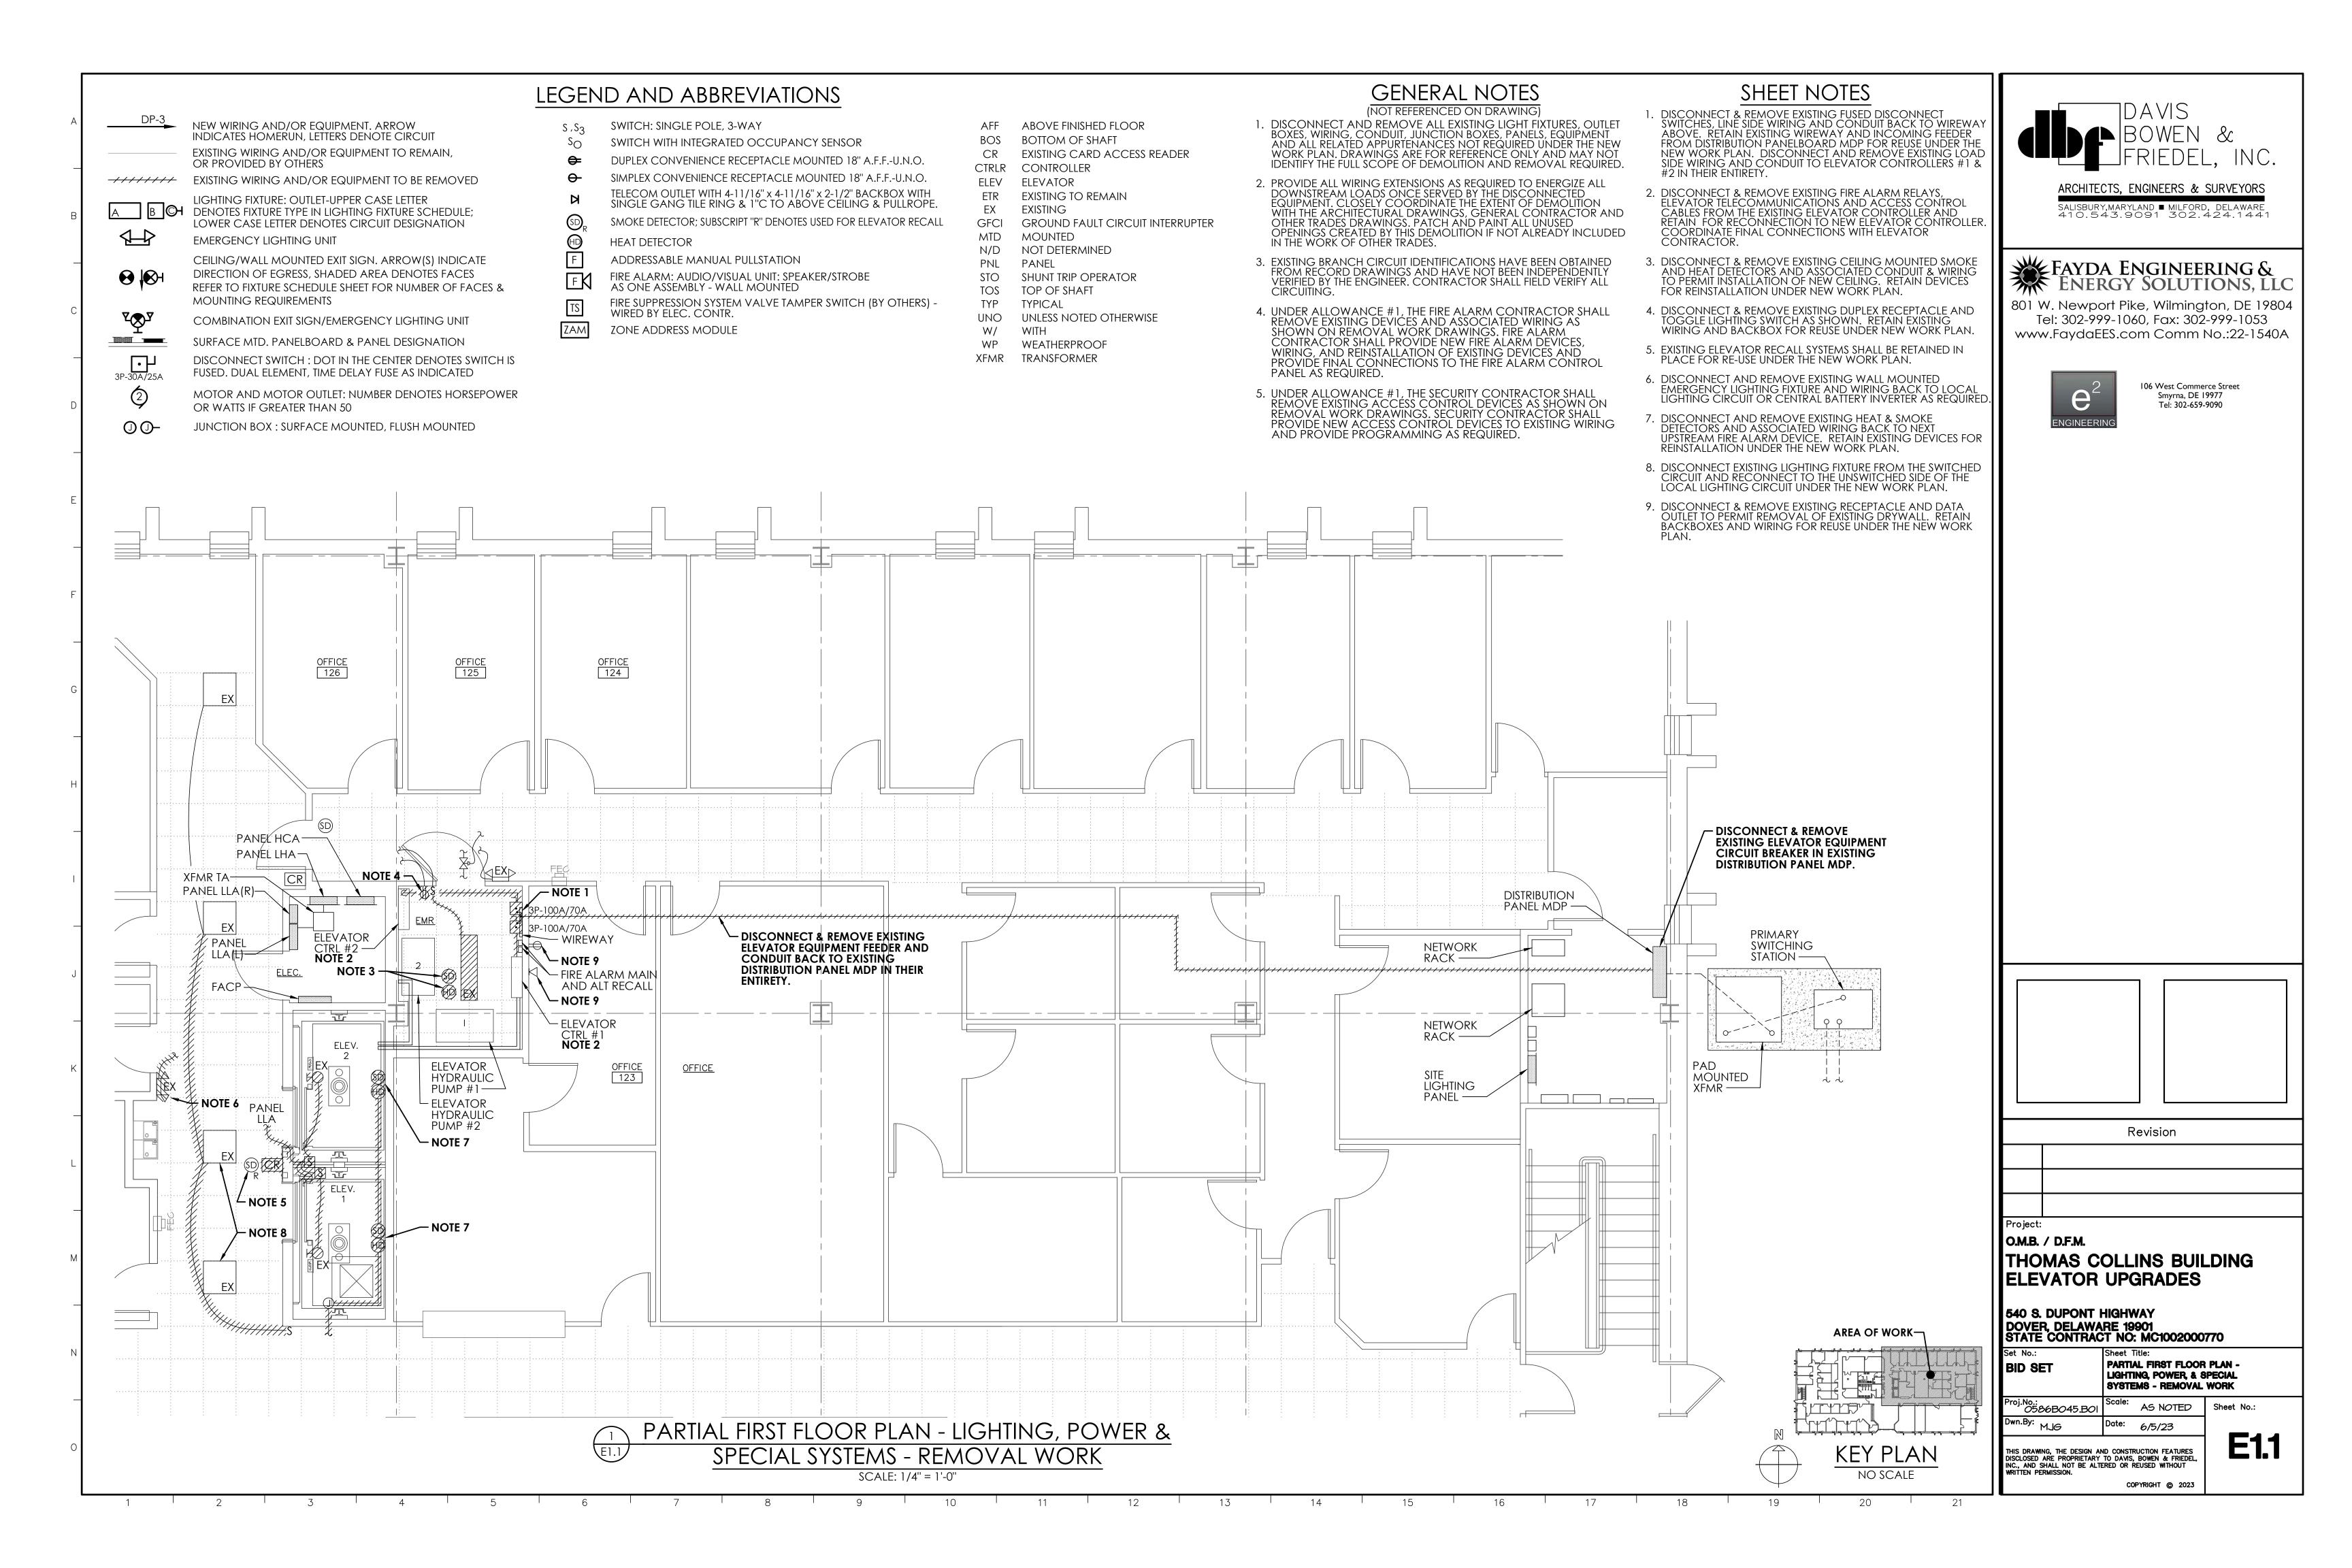

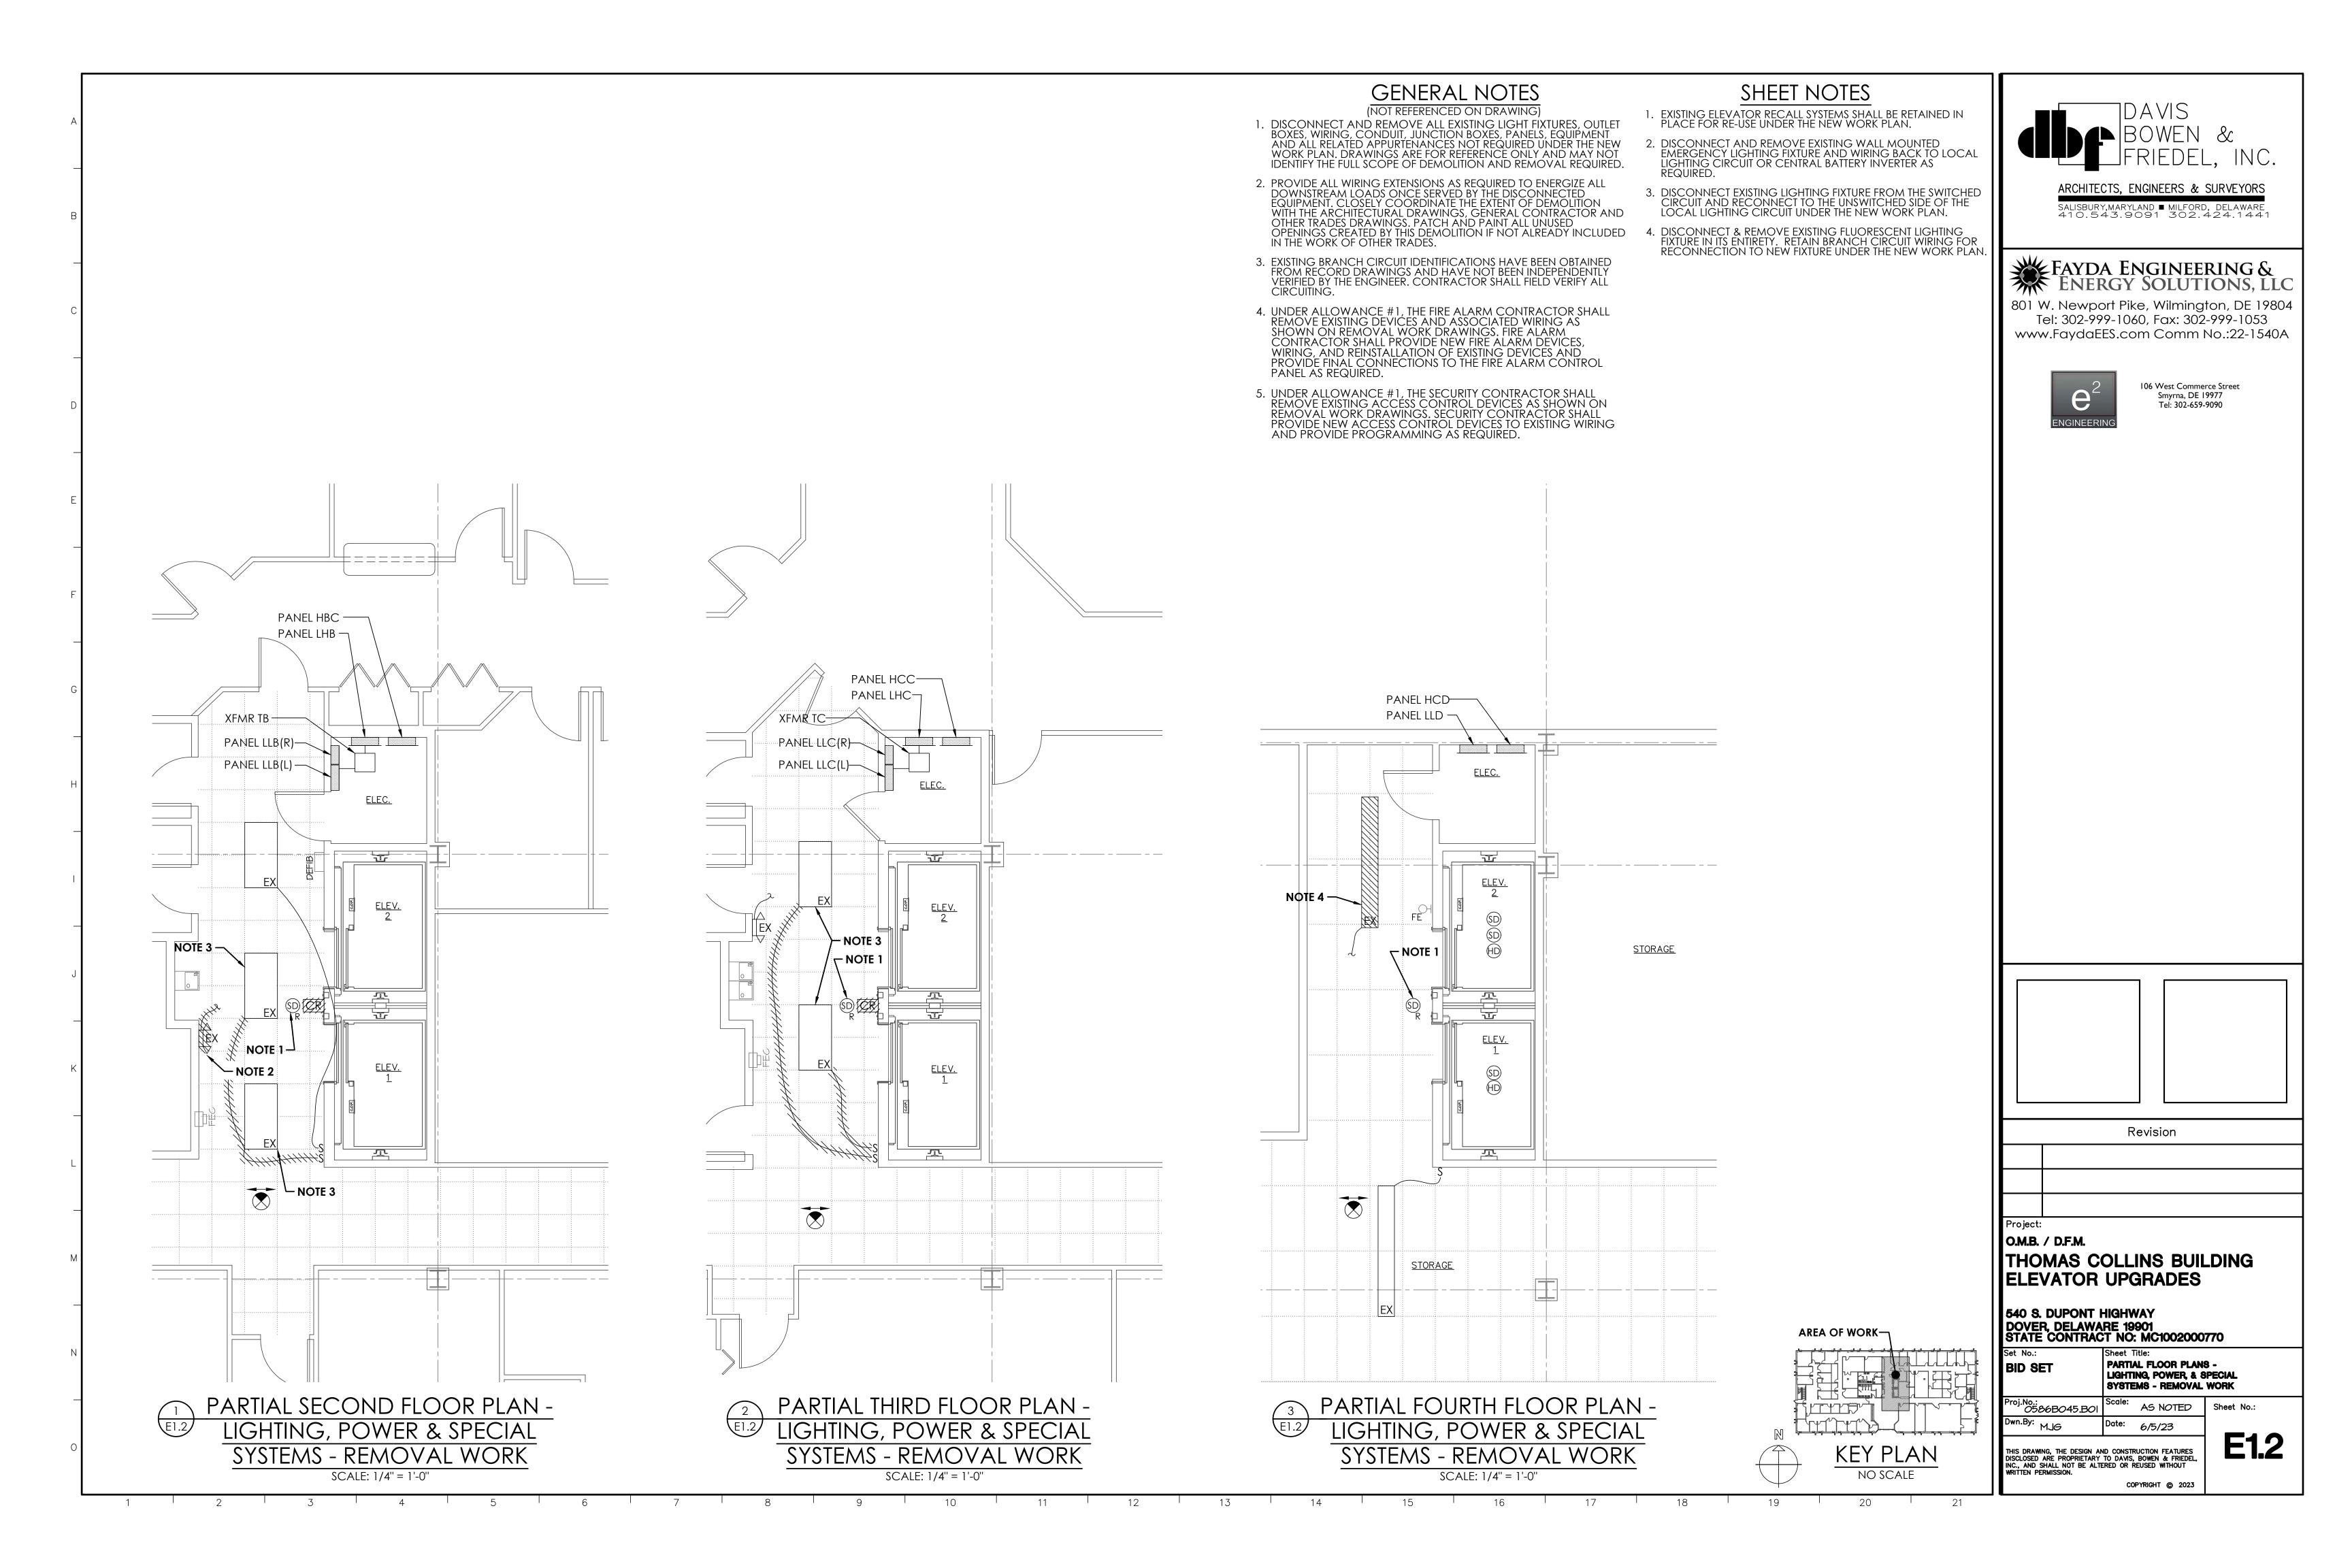

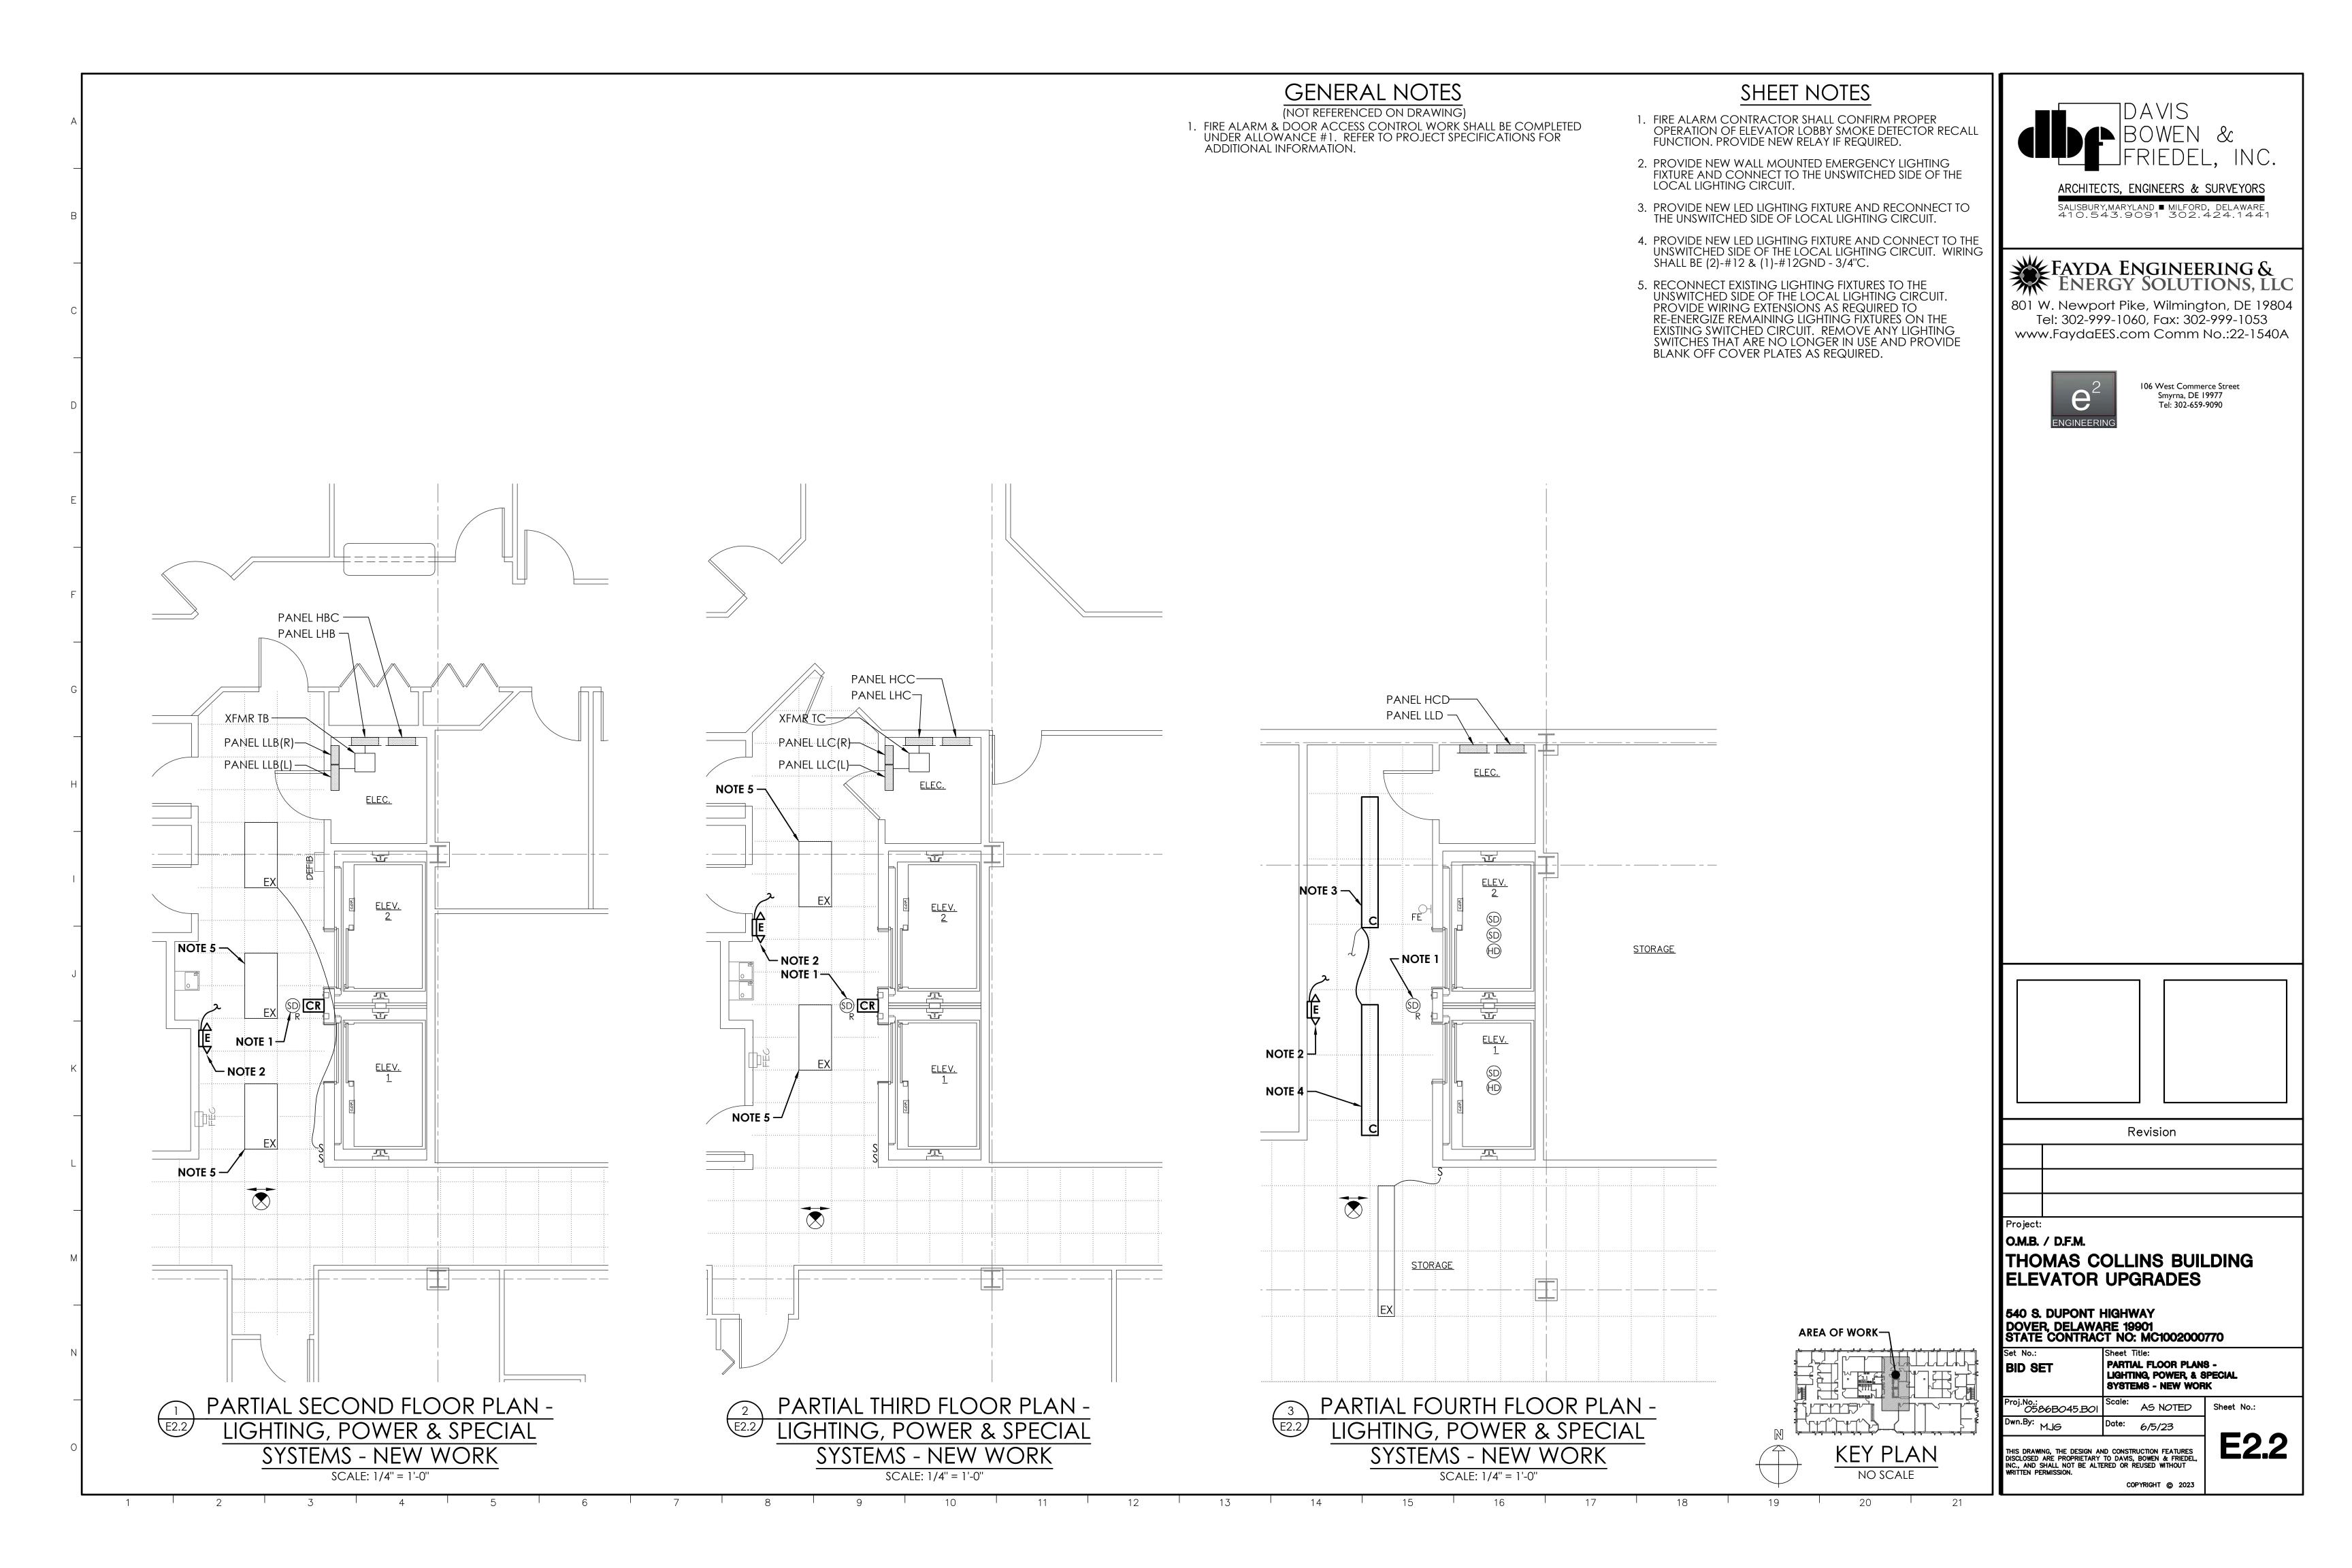

	LIGHTING FIXTURE SCHEDULE										
TYPE	MANUF.	CATALOG NUMBER	LAMP BLST	<del></del>	AMP DA	ATA WATT	FIXTURE H.I.D.	TYPE LED	MOUNTING	REMARKS	ALTERNATE MANUFACTURERS
Α	COLUMBIA	LCL-4-35-ML-E-U	-/-	-	3.5K	42	-	Х	CEILING/ SURFACE	ELEVATOR MACHINE ROOM	APPROVED EQUAL
В	COLUMBIA	LXEM-2-35-ML-RFA-E-U	-/-	-	3.5K	39	-	Х	WALL/ SURFACE	ELEVATOR PIT LINEAR LIGHTING FIXTURE	APPROVED EQUAL
С	COLUMBIA	CSL8-LSCS-GLH5 (SET TO "LOW" LUMEN)	-/-	-	3.5K	74	-	Х	CEILING/ CABLE	8' LED FIXTURE WITH SWITCHABLE LUMENS, 4TH FLOOR LOBBY	APPROVED EQUAL
Е	DUAL-LITE	LZ-15-03L	2/-	-	-	6	-	Х	WALL/ SURFACE	EMERGENCY BATTERY UNIT 2 LAMPS: 15watt CAPACITY	APPROVED EQUAL

	FEEDER SCHEDULE									
1	(4)-#2/0 & (1)-6GND - 2"C									
2	(4)-#3 & (1)-8GND - 1-1/4"C									
3	(3)-#3 & (1)-8GND - 1-1/4"C									
4	(2)-#12 & (1)-#12GND - 3/4"C									
5	(3)-#12 & (1)-#12GND - 3/4"C									

#### GENERAL NOTES

(NOT REFERENCED ON DRAWING) 1. FIRE ALARM & DOOR ACCESS CONTROL WORK SHALL BE COMPLETED UNDER ALLOWANCE #1. REFER TO PROJECT SPECIFICATIONS FOR ADDITIONAL INFORMATION.

#### SHEET NOTES

- 1. CONNECT NEW BRANCH CIRCUIT WIRING TO EXISTING SPARE 1P-20A CIRCUIT BREAKER.
- PROVIDE NEW 2P-15A CIRCUIT BREAKER IN EXISTING PANEL LLA(L) AND CONNECT COMPLETE.
- 3. PROVIDE NEW 3P-175A CIRCUIT BREAKER IN EXISTING DISTRIBUTION PANEL MDP AS SHOWN. NEW CIRCUIT BREAKER SHALL MATCH AIC RATING OF EXISTING DISTRIBUTION PANEL




ARCHITECTS, ENGINEERS & SURVEYORS SALISBURY, MARYLAND MILFORD, DELAWARE 410.543.9091 302.424.1441


## FAYDA ENGINEERING & ENERGY SOLUTIONS, LLC

801 W. Newport Pike, Wilmington, DE 19804 Tel: 302-999-1060, Fax: 302-999-1053 www.FaydaEES.com Comm No.:22-1540A



106 West Commerce Street Smyrna, DE 19977 Tel: 302-659-9090

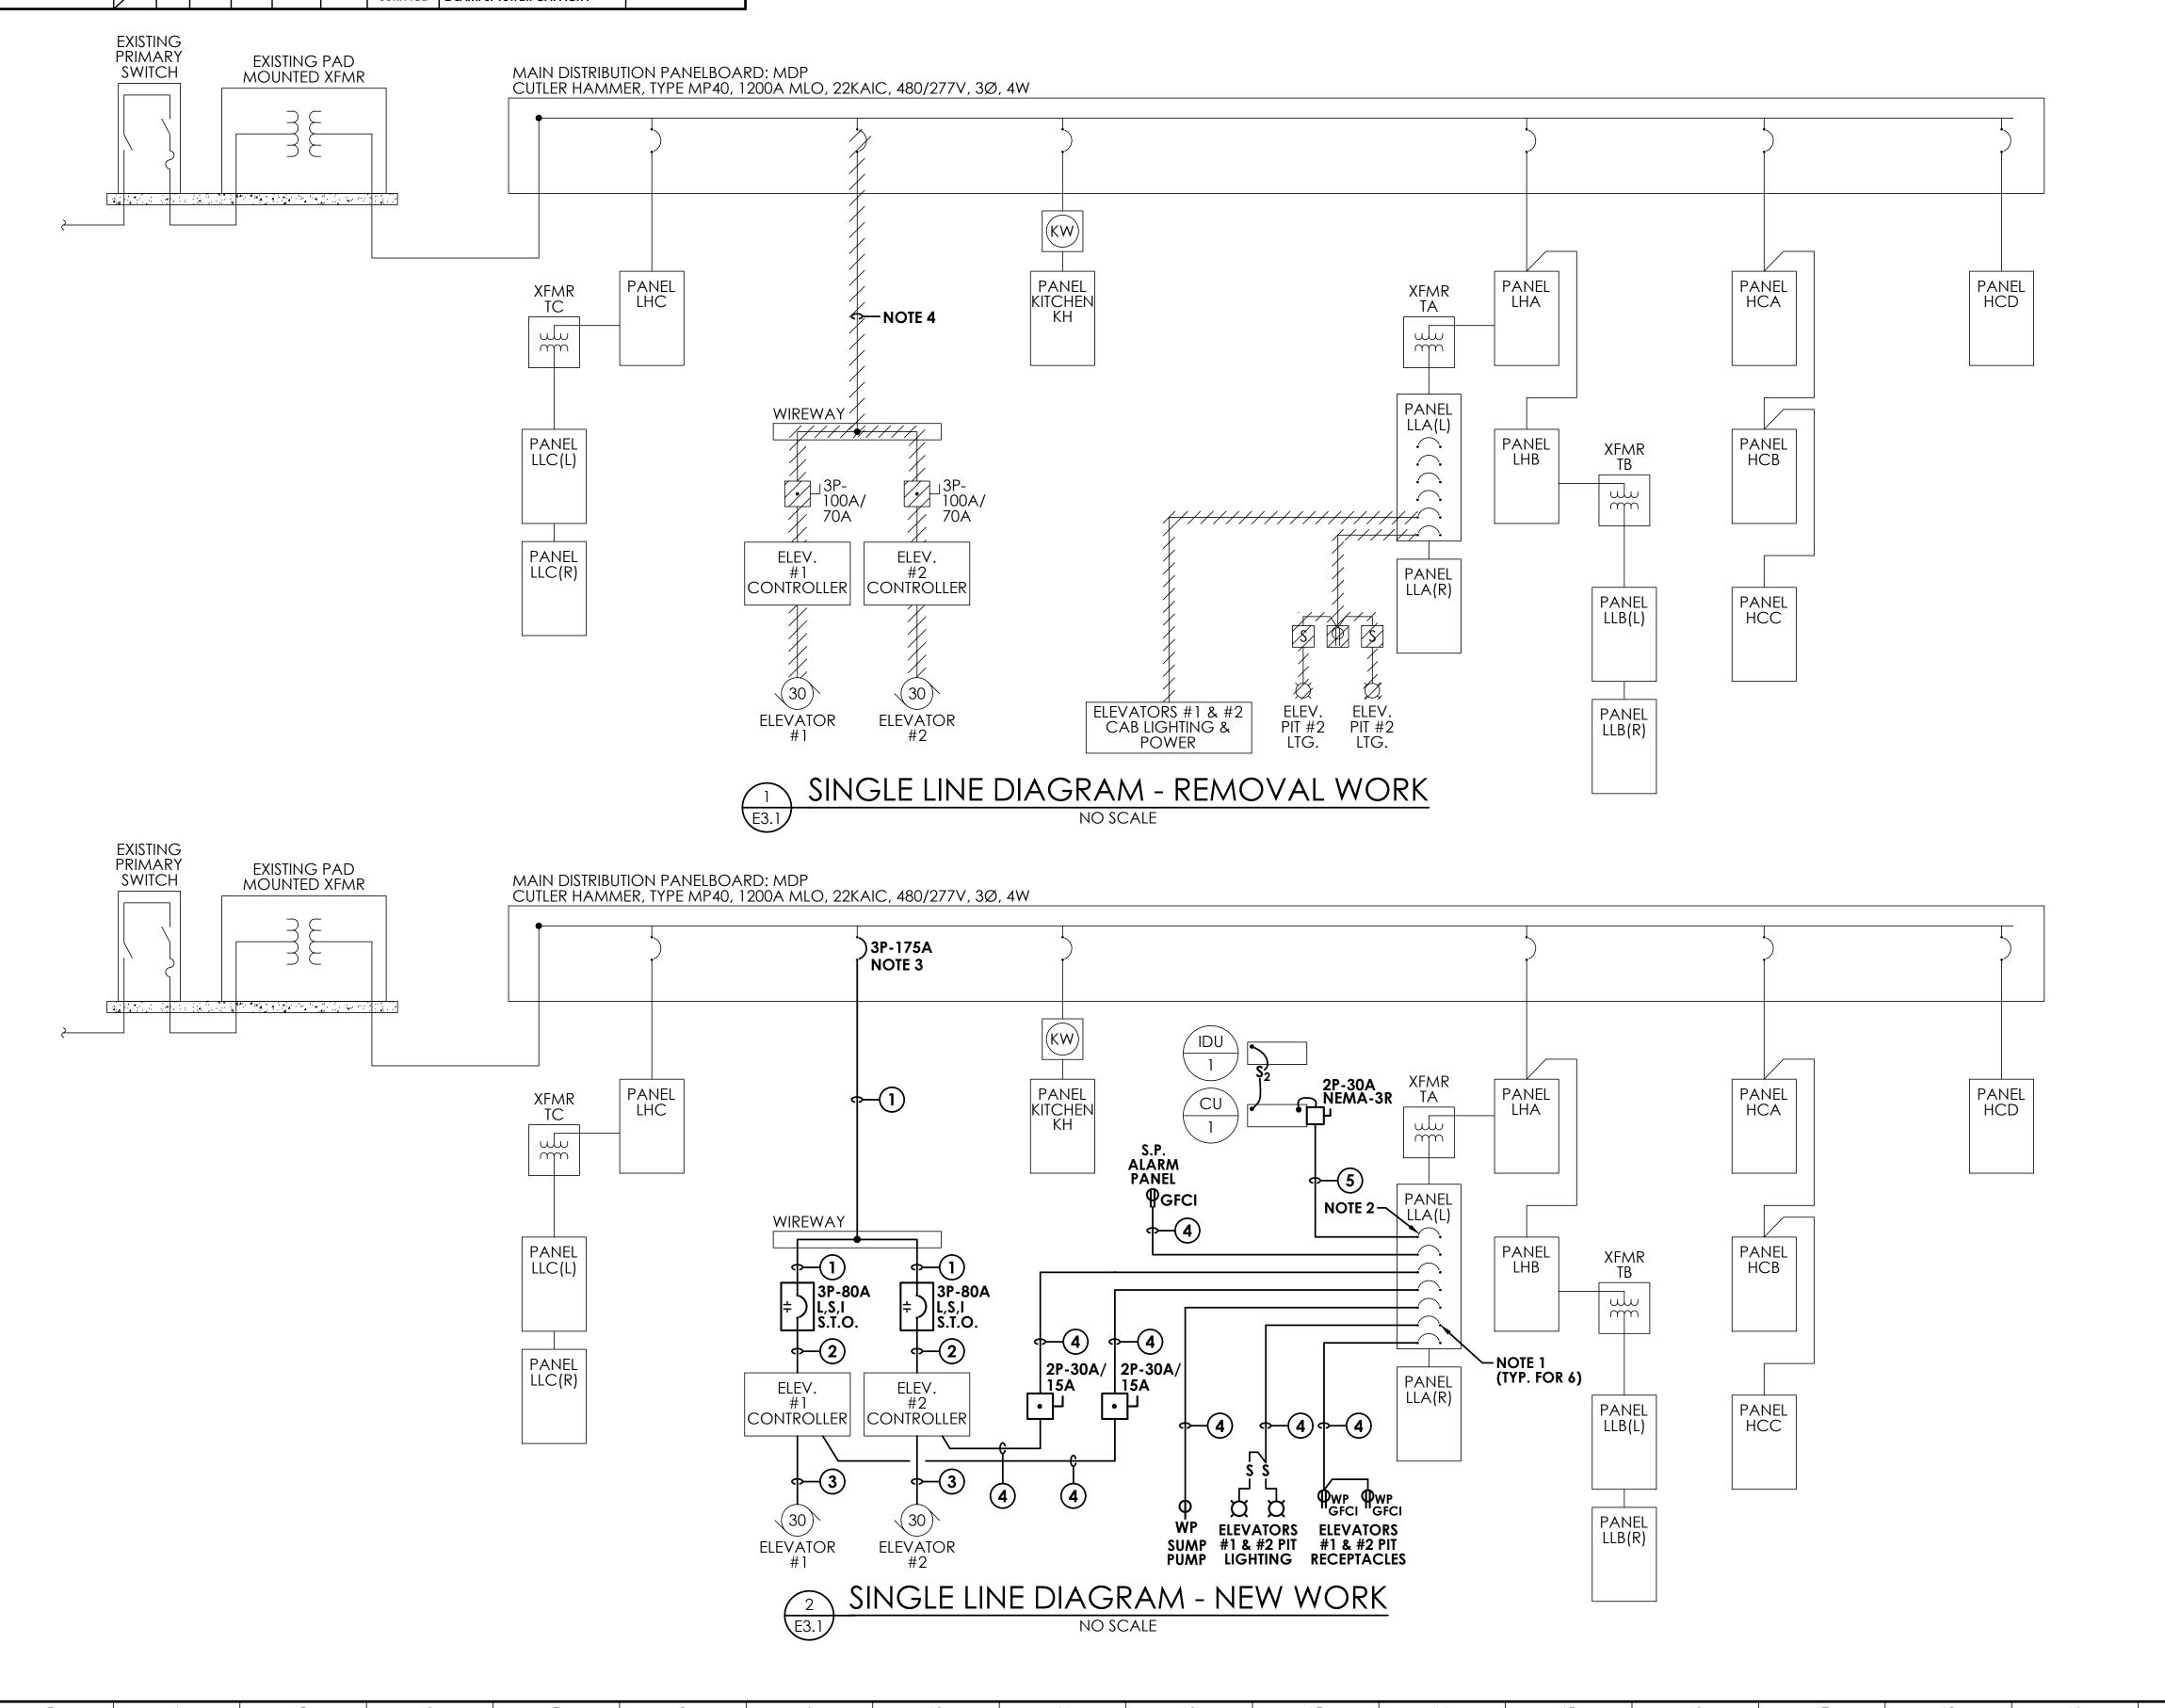

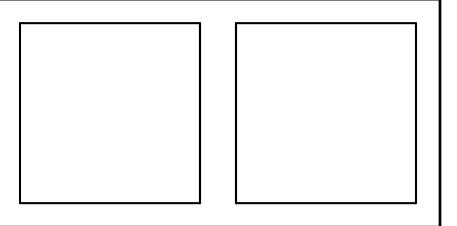

Revision

O.M.B. / D.F.M. THOMAS COLLINS BUILDING **ELEVATOR UPGRADES** 

540 S. DUPONT HIGHWAY DOVER, DELAWARE 19901 STATE CONTRACT NO: MC1002000770

Sheet Title:
SINGLE LINE DIAGRAM,
SCHEDULES & DETAILS BID SET Proj.No.: *0*5*86*B045.B01 AS NOTED

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