

Richard Y. Johnson & Son, Inc.

General Contractors & Construction Managers
Serving Delaware Since 1946
www.ryjson.com

18404 Johnson Rd PO Box 105 Lincoln, DE 19960 Phone 302-422-3732 Fax 302-422-4696

Capital School District
Central Middle School
Interior Renovations
211 Delaware Ave. Dover Delaware 19901
Bid Pac E— Contracts 1 thru 10
October 7, 2024

Addendum No. 1

Attention all Prospective Bidders:

The following clarifications, changes and /or additions shall by this reference be incorporated into the contract documents as though dully set forth therein.

Addendum No. 1 consists of: RYJ Written directive (2 pages) Pre-Bid Meeting Agenda (2 pages) BMG Written directive (2 pages) A Drawings (3 Drawings) E Drawings (4 Drawings)

*Note: Pre-Bid Sign In Sheets will be available in Addendum 2

Non - Technical Specifications

NOTE: All Prime Contractors are responsible for bidding from a full set of bidding documents.

This project is a State wage rated project.

No administrative items shall be delivered to the job site.

All correspondence with Architect, Engineer, Owner, Etc. must go through this office.

Application for Payment

All bills are due the $\underline{25^{th}}$ of the month. Bills must be on for AIA G702/CMa. Billing will not be processed early, late bills will be rejected.

A total of five copies of each bill and corresponding waiver (one notarized original and 4 copies) are required. Faxed copies will not be accepted.

General Conditions

Please refer to Section 9.3.2; any stored material (including on-site storage) being billed during a pay period must be insured and a certificate of stored material be included with your application for payment. Your payment will not be processed and your bill will be rejected for that period.

Stored materials must stay in the stored materials column, and must be insured, until the material has been incorporated into the building.

Shop Drawings, Product Data and Samples

Submittals are to be submitted via email for review and approval, if certain items are deemed not emailable then ten (10) copies of all submittals are required. Inadequate amounts will be rejected.

End of Addendum No. 1



Richard Y. Johnson & Son, Inc.

General Contractors & Construction Managers
Serving Delaware Since 1946
www.ryjson.com

18404 Johnson Rd PO Box 105 Lincoln, DE 19960 Phone 302-422-3732 Fax 302-422-4696

PRE-BID MEETING

October 3, 2024 2:00 pm Central Middle School Interior Renovations Project No. 2021101.00

> Bid Pac E Agenda

1. Attendees at Pre-Bid Meeting

Owner-Capital School District – James Baustert Construction Manager – Richard Y. Johnson & Son, Inc. Architect – Becker Morgan Group

- 2. Review projects' description and time frame
 - You will be bidding Bid Pac D -
- E-1 Site Work
- E-2 Concrete & Masonry Work
- E-3 Carpentry & General Work
- E-4 Aluminum Storefront/Windows/Glass & Glazing
- E-5 Drywall/Metal Stud/Acoustical Work
- E-6 Floor Covering Work
- E-7 Caulking/Painting
- E-8 Mechanical
- E-9 Sprinkler System
- E-10 Electrical
- Project involves the interior renovations of the existing Central Middle School.
- 3. Review Bid date and location
 - October 24, 2024 @ 2:00pm
 - Central Middle School located at 211 Delaware Ave. Dover Delaware 19901 in the auditorium.

All **mailed bids** must be received by **12:00pm** the day of the bid opening, October 24, 2024 at the Capital School District Office located at 198 Commerce Way, Dover Delaware 19904.

Bidder bears the risk of late delivery.

- Bids will be publicly opened and read aloud at the Central Middle School Auditorium,
- 4. Review the bidding procedures and bonding requirements
 - You are bidding a full set of documents.
 - You must use bid form provided in bid documents and/or as revised in Addendums
 - Review scope of work, section 011100 Summary of Work
 - No exclusions from your scope of work or bid will be rejected!!
 - 10% Bid Bond is required.
 - Public bid opening.
 - This is a **NON-MANDATORY** pre-bid meeting.
- 5. Review the Project

- Owner to provide building permits; contractor provides all other permits, licenses and inspection fees
- Seven (7) Alternates
- Four (4) Allowances
 - Contract 2 Concrete & Masonry Work \$25,000 Unforeseen Conditions
 - Contract 3 Carpentry & General Work \$100,000 Unforeseen Conditions
 - Contract 8 Mechanical \$25,000 Unforeseen Conditions
 - Contract 10 Electrical \$25,000 Unforeseen Conditions
- Zero (0) Unit Prices
- 6. Receive Bidding questions R. F. I. to be forwarded to Construction Manager. Email address is <u>jdixon@ryjson.com</u>.
 - RFI's to be in written form only, with plan number or specification number noted with question.
 - No RFI's shall be accepted after 12 noon on Thursday, October 17th, 2024.
 - All substitutions shall be submitted no later than 12 noon on Thursday, October 17th, 2024.
 - State prevailing wage rates apply.
- 7. Bidding documents
 - www.ryjson.com under plan room
 - Additional contract Documents and partial sets can be purchased at RCI Printing & Graphics, 298 Churchmans Road, New Castle Delaware, (302) 328-5019
 - -Documents Shown on My Market Place State of Delaware website are **NOT** for Bidding.

For Bidding, you must use the documents from the RYJ website.

- 8. Drug Testing/Craft Training Requirements
 - -All Prime Contractors are to include a signed affidavit that is included in the project documents.
- 9. Review Subcontractor List Requirements
- 10. Site Visit: View after Pre-Bid Meeting
- 11. Receive questions
- 12. Summation and Conclusion



ENGINEERING

ADDENDUM 1

OWNER ARCHITECT

CONSULTANTS CONTRACTOR **FIELD OTHER**

X Capital School District X Becker Morgan Group, Inc. X Pilottown Engineering, CMTA Inc.

X Richard Y. Johnson and Son, Inc.

DATE: 10/07/2024

PROJECT: Central Middle to Elementary School Interior Renovation

PROJECT NO: 2021101.00

You are hereby directed to execute promptly this Field Memo that interprets the Contract Documents or orders minor changes in the Work without change in Contract Sum or Contract Time.

If you consider that a change in Contract Sum or Contract Time is required, please submit your itemized proposal to the Architect immediately and before proceeding with this Work. If your proposal is found to be satisfactory and in proper order, this Field Memo will in that event be superseded by a Change Order.

Description:

- 1. General Addendum Notes:
 - a. All countertops are to be solid surface.
 - b. All casework is plastic laminate casework with a maximum of 3 total plastic laminate types.
- 2. A101D-E FIRST FLOOR PLAN AREA D/E
 - a. Detail 1:
 - i. **ADD** exam curtains (3) in nurse's suite.
- 3. A106-E FIRST FLOOR FINISH PLAN AREAS B, D/E (BASE BID)
 - a. General Symbol Legend:
 - i. **DELETE** graphic pattern for RUB-1.
 - b. Material Finish Legend:
 - i. **ADD** SS-1 information.
 - ii. REVISE SVT-1 and SVT-2 description to "Sheet Vinyl Tile".
- 4. A602-E INTERIOR FLOORING TRANSITION DETAILS
 - a. DELETE details S6 and S9.
 - b. Details S8 and S14:
 - i. **REVISE** drawing title and drawing note from "Athletic" to "Sheet".
- 5. ED-101B FIRST FLOOR ELECTRICAL DEMOLITION PLAN AREA B
 - a. ADD demolished lights in corridor B151.
- 6. E-201B FIRST FLOOR ELECTRICAL LIGHTING PLAN AREA B
 - a. ADD two (2) A6 light fixtures and one (1) A6(EM) light fixture in corridor B1.
 - b. **ADD** occupancy sensor in corridor B1.
 - c. ADD general note O.
- 7. E-201D/E FIRST FLOOR ELECTRICAL LIGHTING PLAN AREA D/E
 - REVISE lights in grid in Office D112A.
- 8. E-501 ELECTRICAL DETAILS

a. ADD lighting fixtures A6 and A6(EM) to lighting fixture schedule.

Attachments:


Becker Morgan Group, Inc. drawings: A101D-E, A106-E, and A602-E dated 09.13.2024


CMTA, Inc. Drawings: ED-101B, E-201B, E-201D/E, and E-501 dated 09.13.2024

ARCHITECT: Becker Morgan Group, Inc.

BY: Brad Hastings, AIA

202110100_Addendum1_Narrative

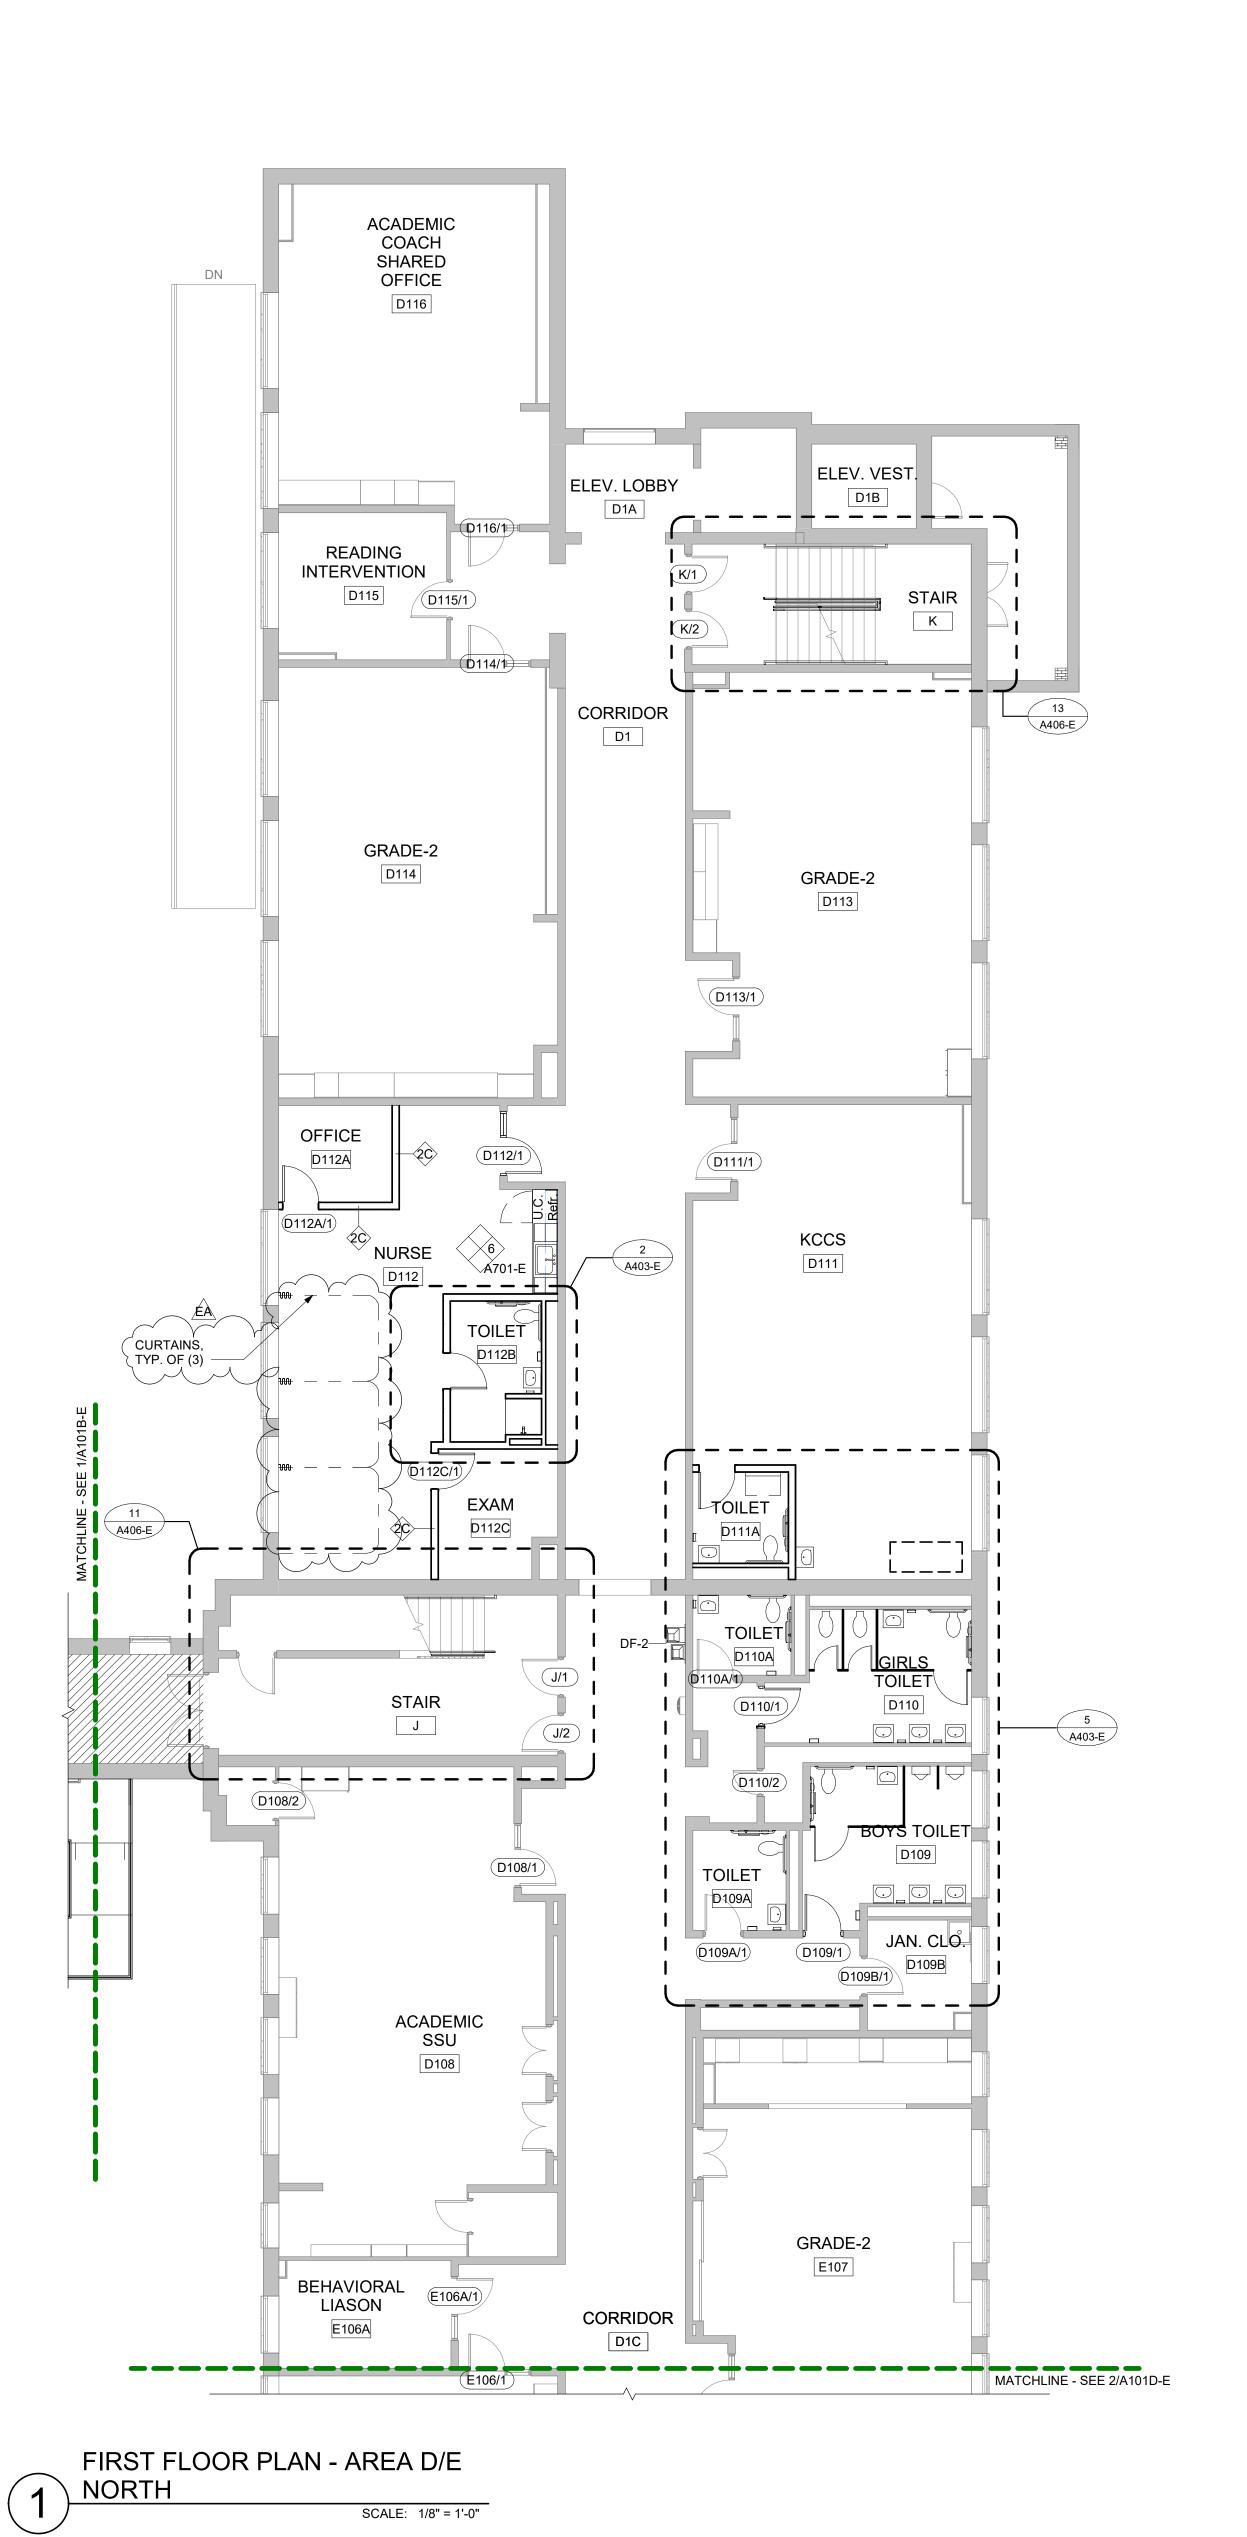

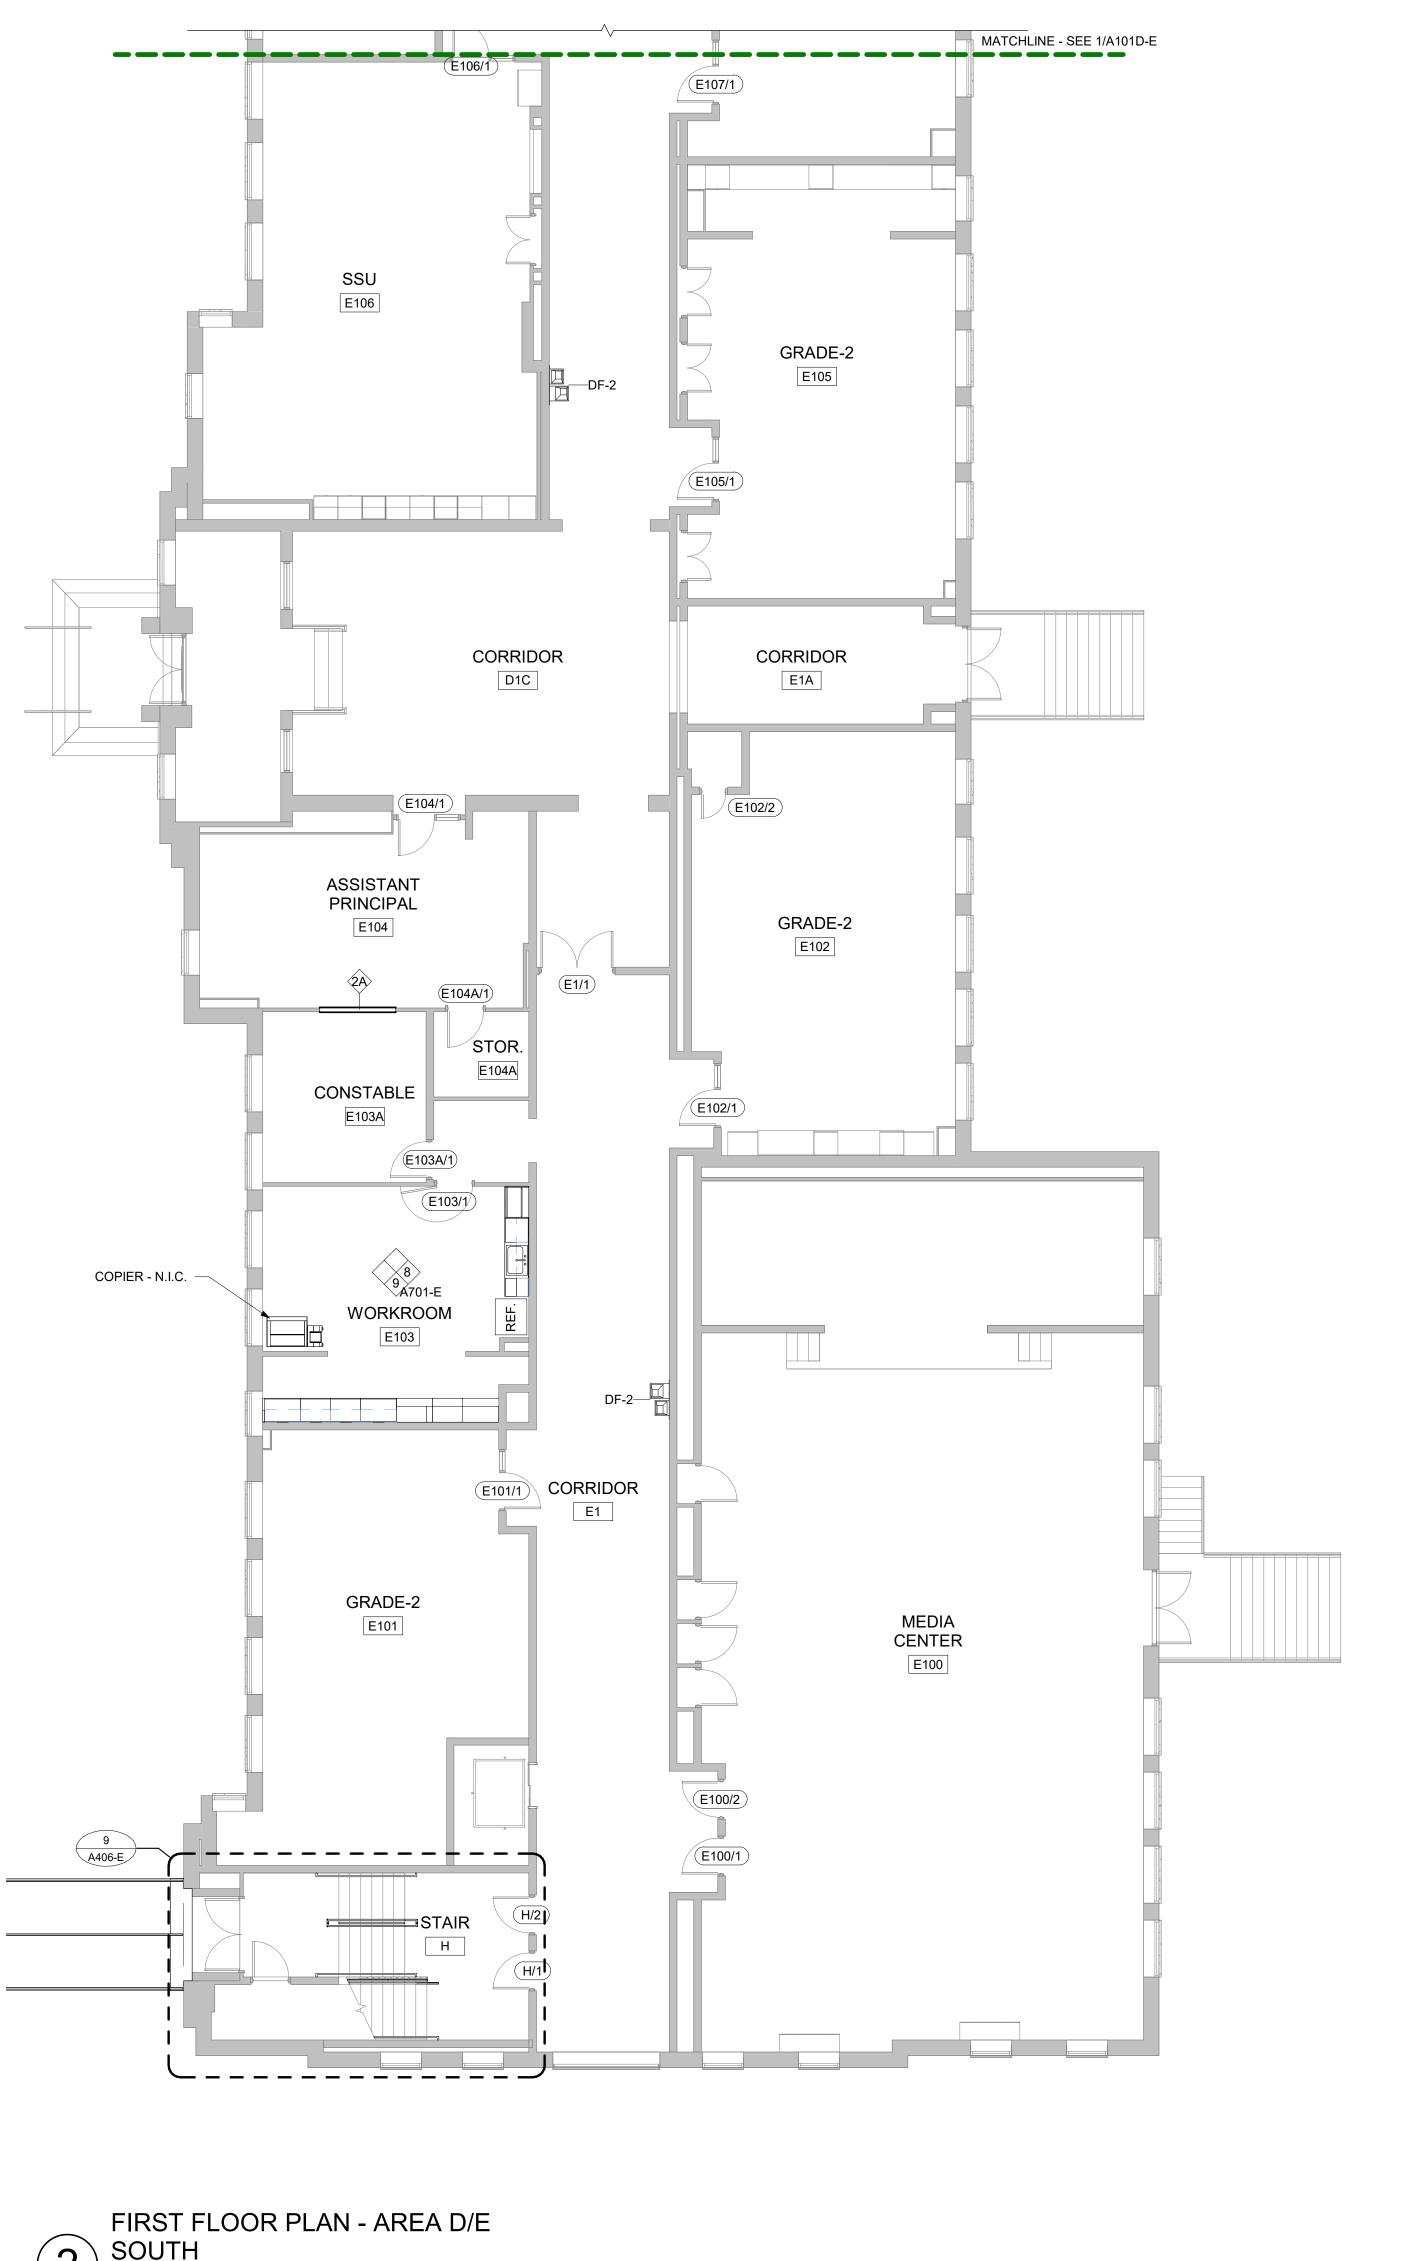



G R O U P

ARCHITECTURE

ENGINEERING <u>Delaware</u>

> 309 S Governors Ave Dover, DE 19904

302.734.7950

The Tower at STAR Campus

100 Discovery Boulevard, Suite 102

Newark, DE 19713 302.369.3700 **Maryland** 312 West Main St, Suite 300 Salisbury, MD 21801 410.546.9100 North Carolina 3333 Jaeckle Drive, Suite 120 Wilmington, NC 28403 910.341.7600 www.beckermorgan.com

CMTA, INC.

ANNAPOLIS, MD 21401 410-921-3510

STRUCTURAL ENGINEER

CONSTRUCTION MANAGER 18404 JOHNSON AVENUE LINCOLN, DELAWARE 19960

302-422-3732 fax 302-422-4696

LEWES, DE 19958

302-703-1770

FIRE PROTECTION, PLUMBING,

200 WESTGATE CIRCLE, SUITE 404


PILOTTOWN ENGINEERING

17585 NASSAU BOULEVARD, UNIT 3

RICHARD Y. JOHNSON & SON, INC.

MECHANICAL, AND ELECTRICAL ENGINEER

2 SOUTH SCALE: 1/8" = 1'-0"

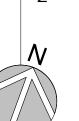

 EA
 10.07.2024
 ADDENDUM 1

 Mark
 Date
 Description

DRAWN BY: CES PROJ MGR: BAH

PROJECT NO:

SCALE:

2021101.00

09.13.2024

1/8" = 1'-0"

GENERAL NOTES

REFER TO A000-SERIES DRAWINGS FOR SLAB AND OTHER

SEE A400-SERIES FOR ENLARGED PLANS AND SECTIONS.

METAL STUD UNLESS OTHERWISE NOTED.

CURTAINWALL, AND STOREFRONT TYPES.


N.I.C. (NOT IN CONTRACT)


CONSTRUCTION TYPES AND TYPICAL DETAILS.


DIMENSIONS ARE TO EXTERIOR FACE OF CONCRETE, MASONRY, OR


SEE A601-E FOR DOOR SCHEDULE, DOOR TYPES AND HOLLOW METAL,

COORDINATE REQUIREMENTS OF WORK WITH ALL OTHER TRADES.

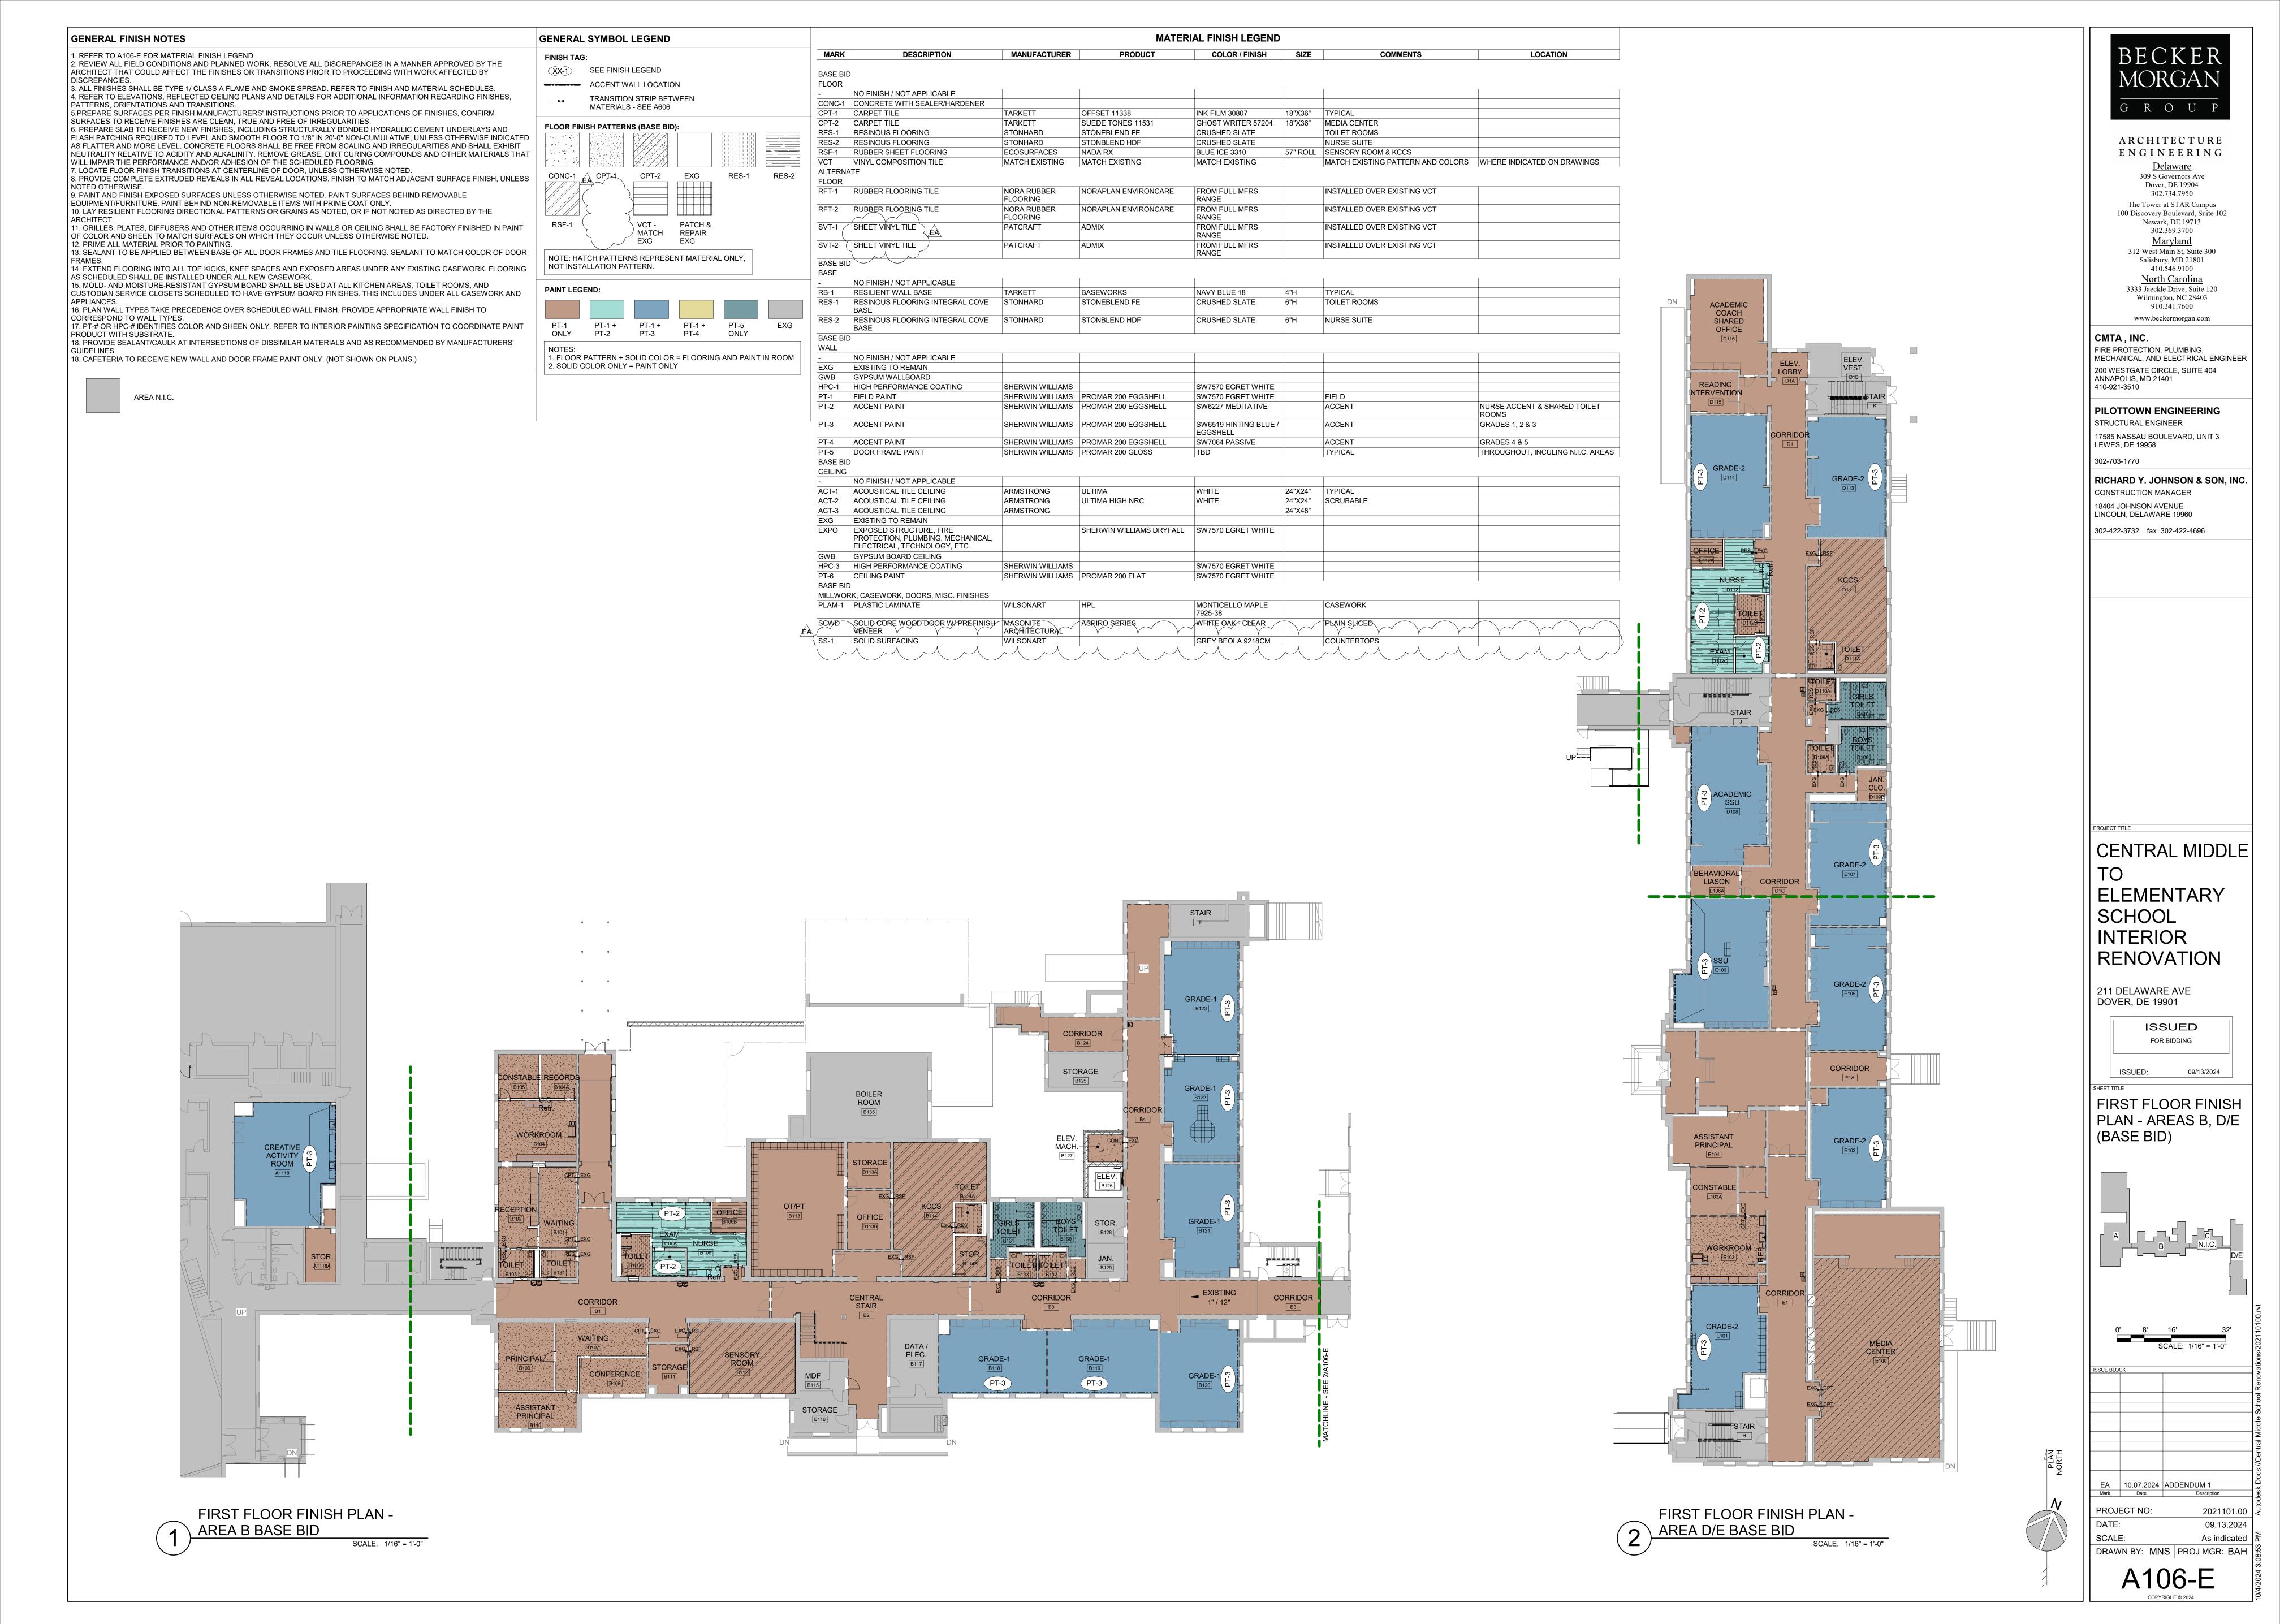

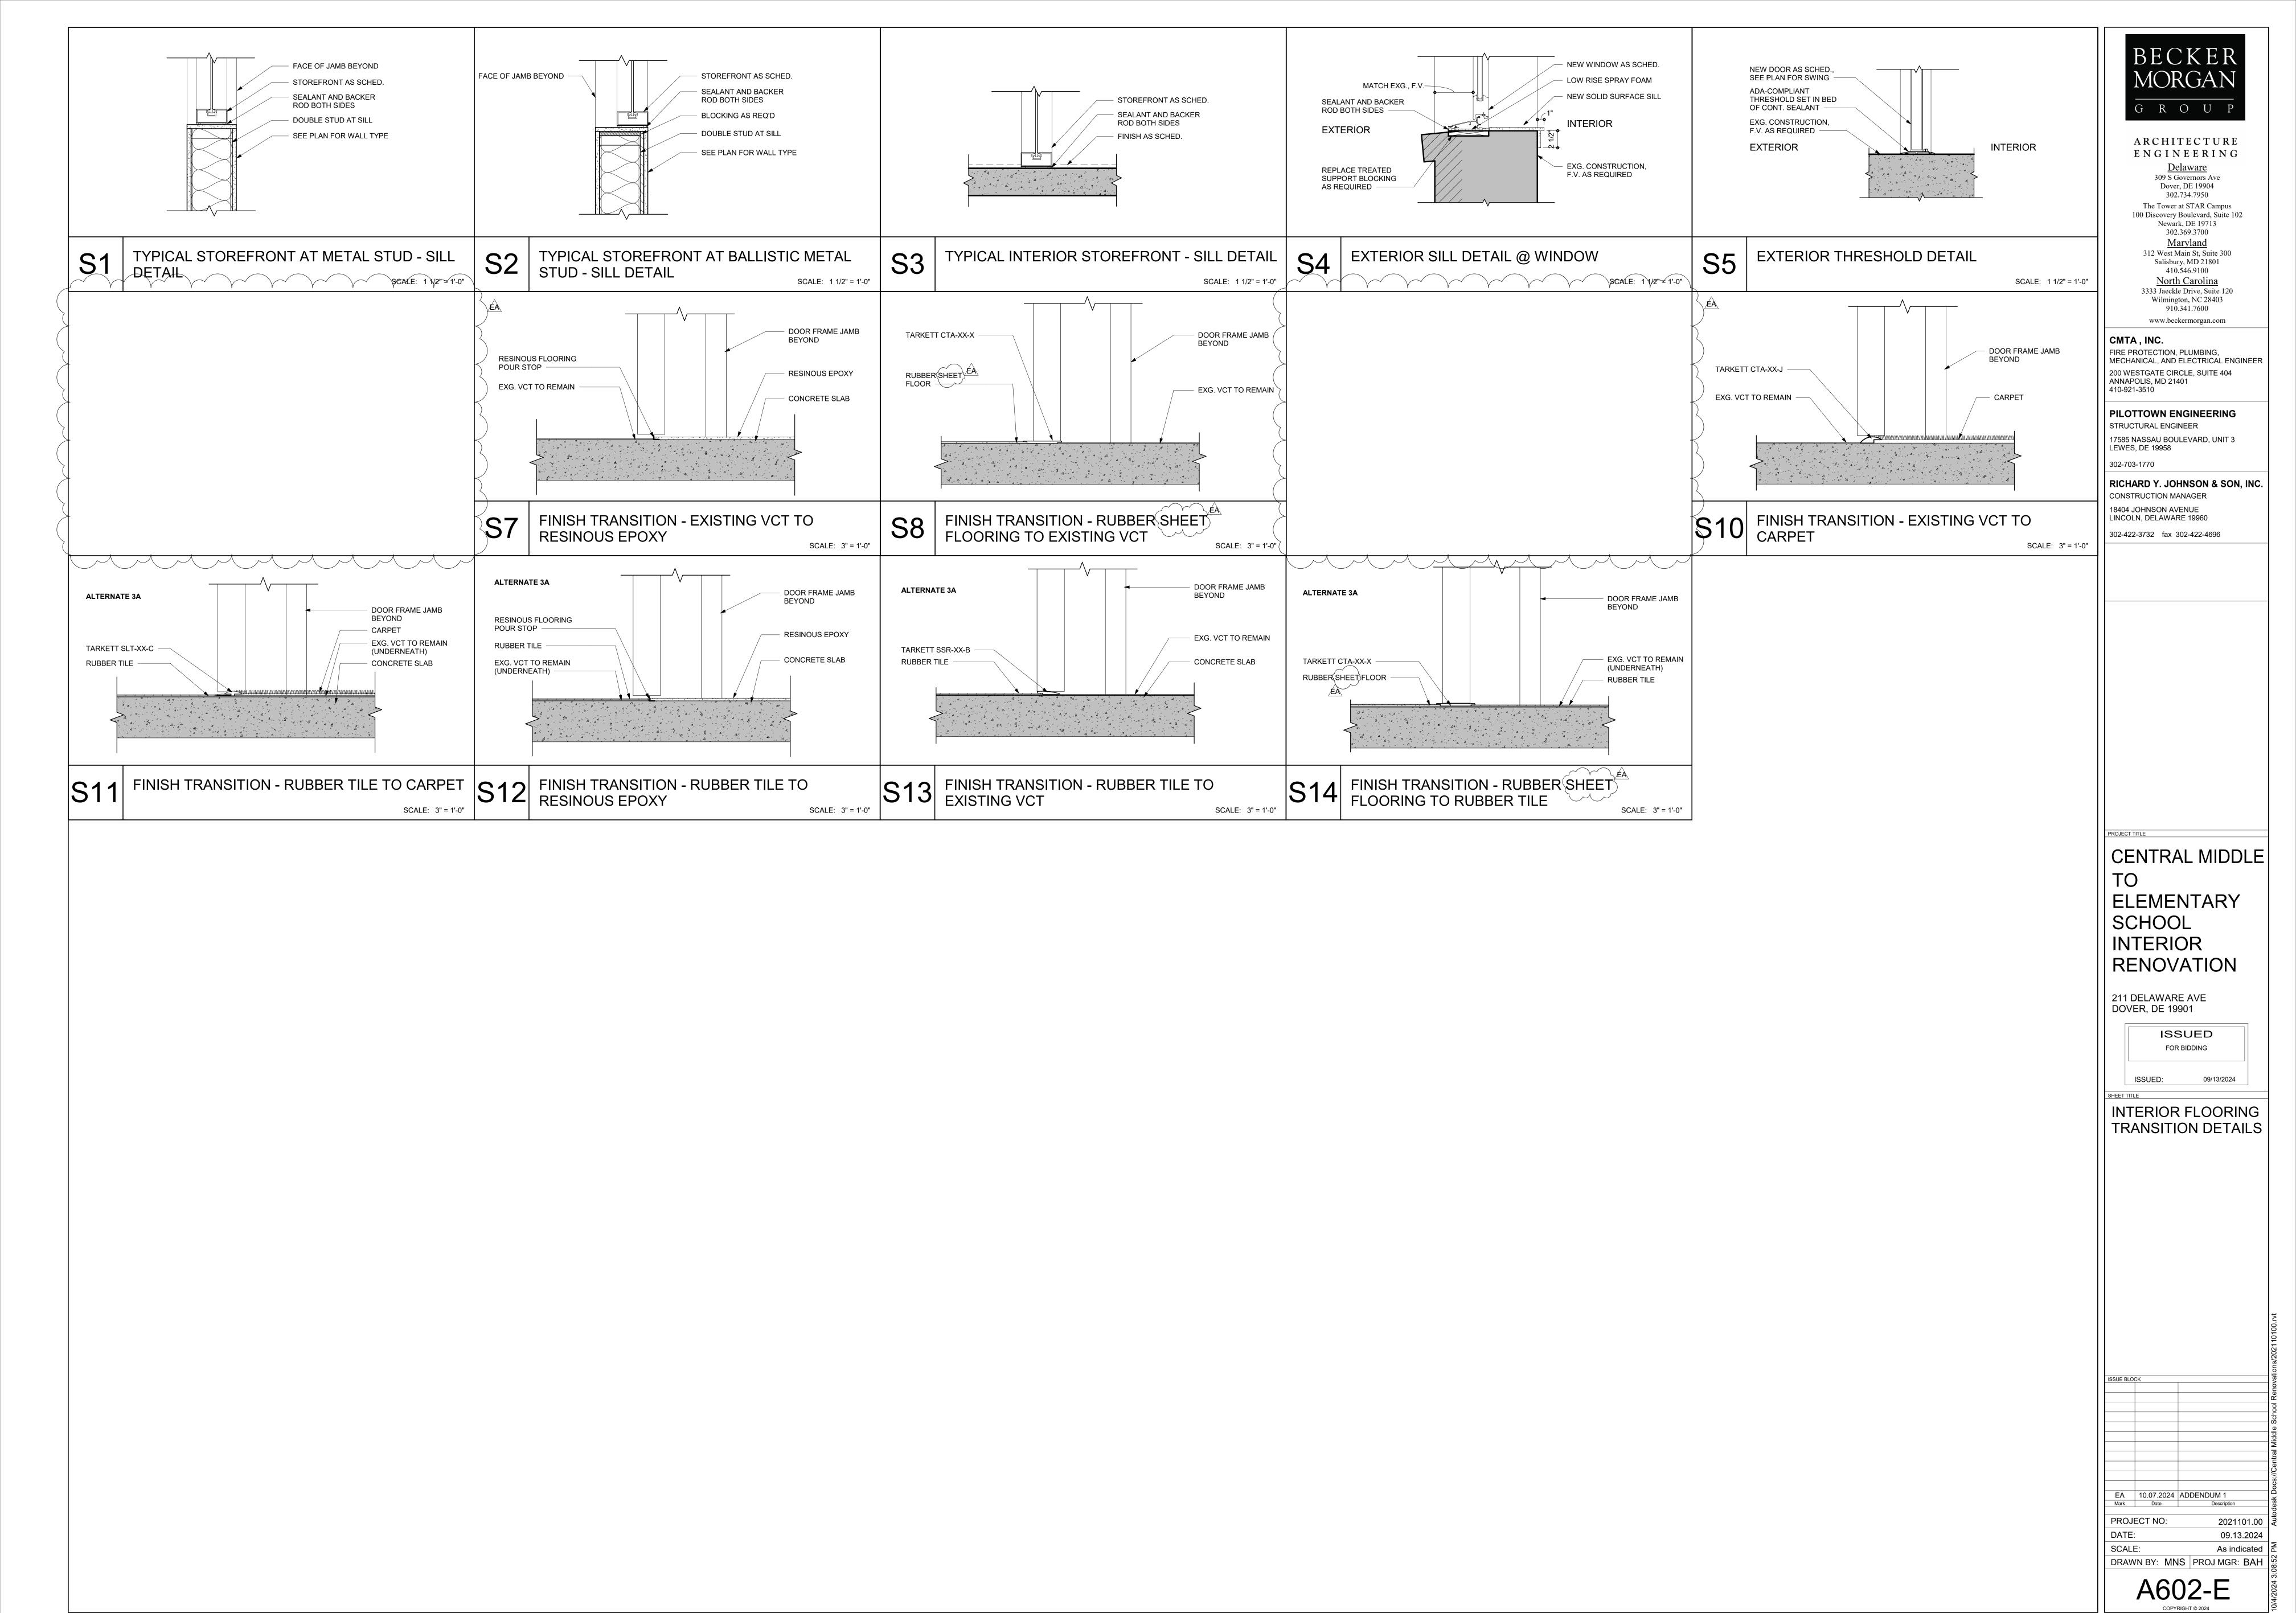

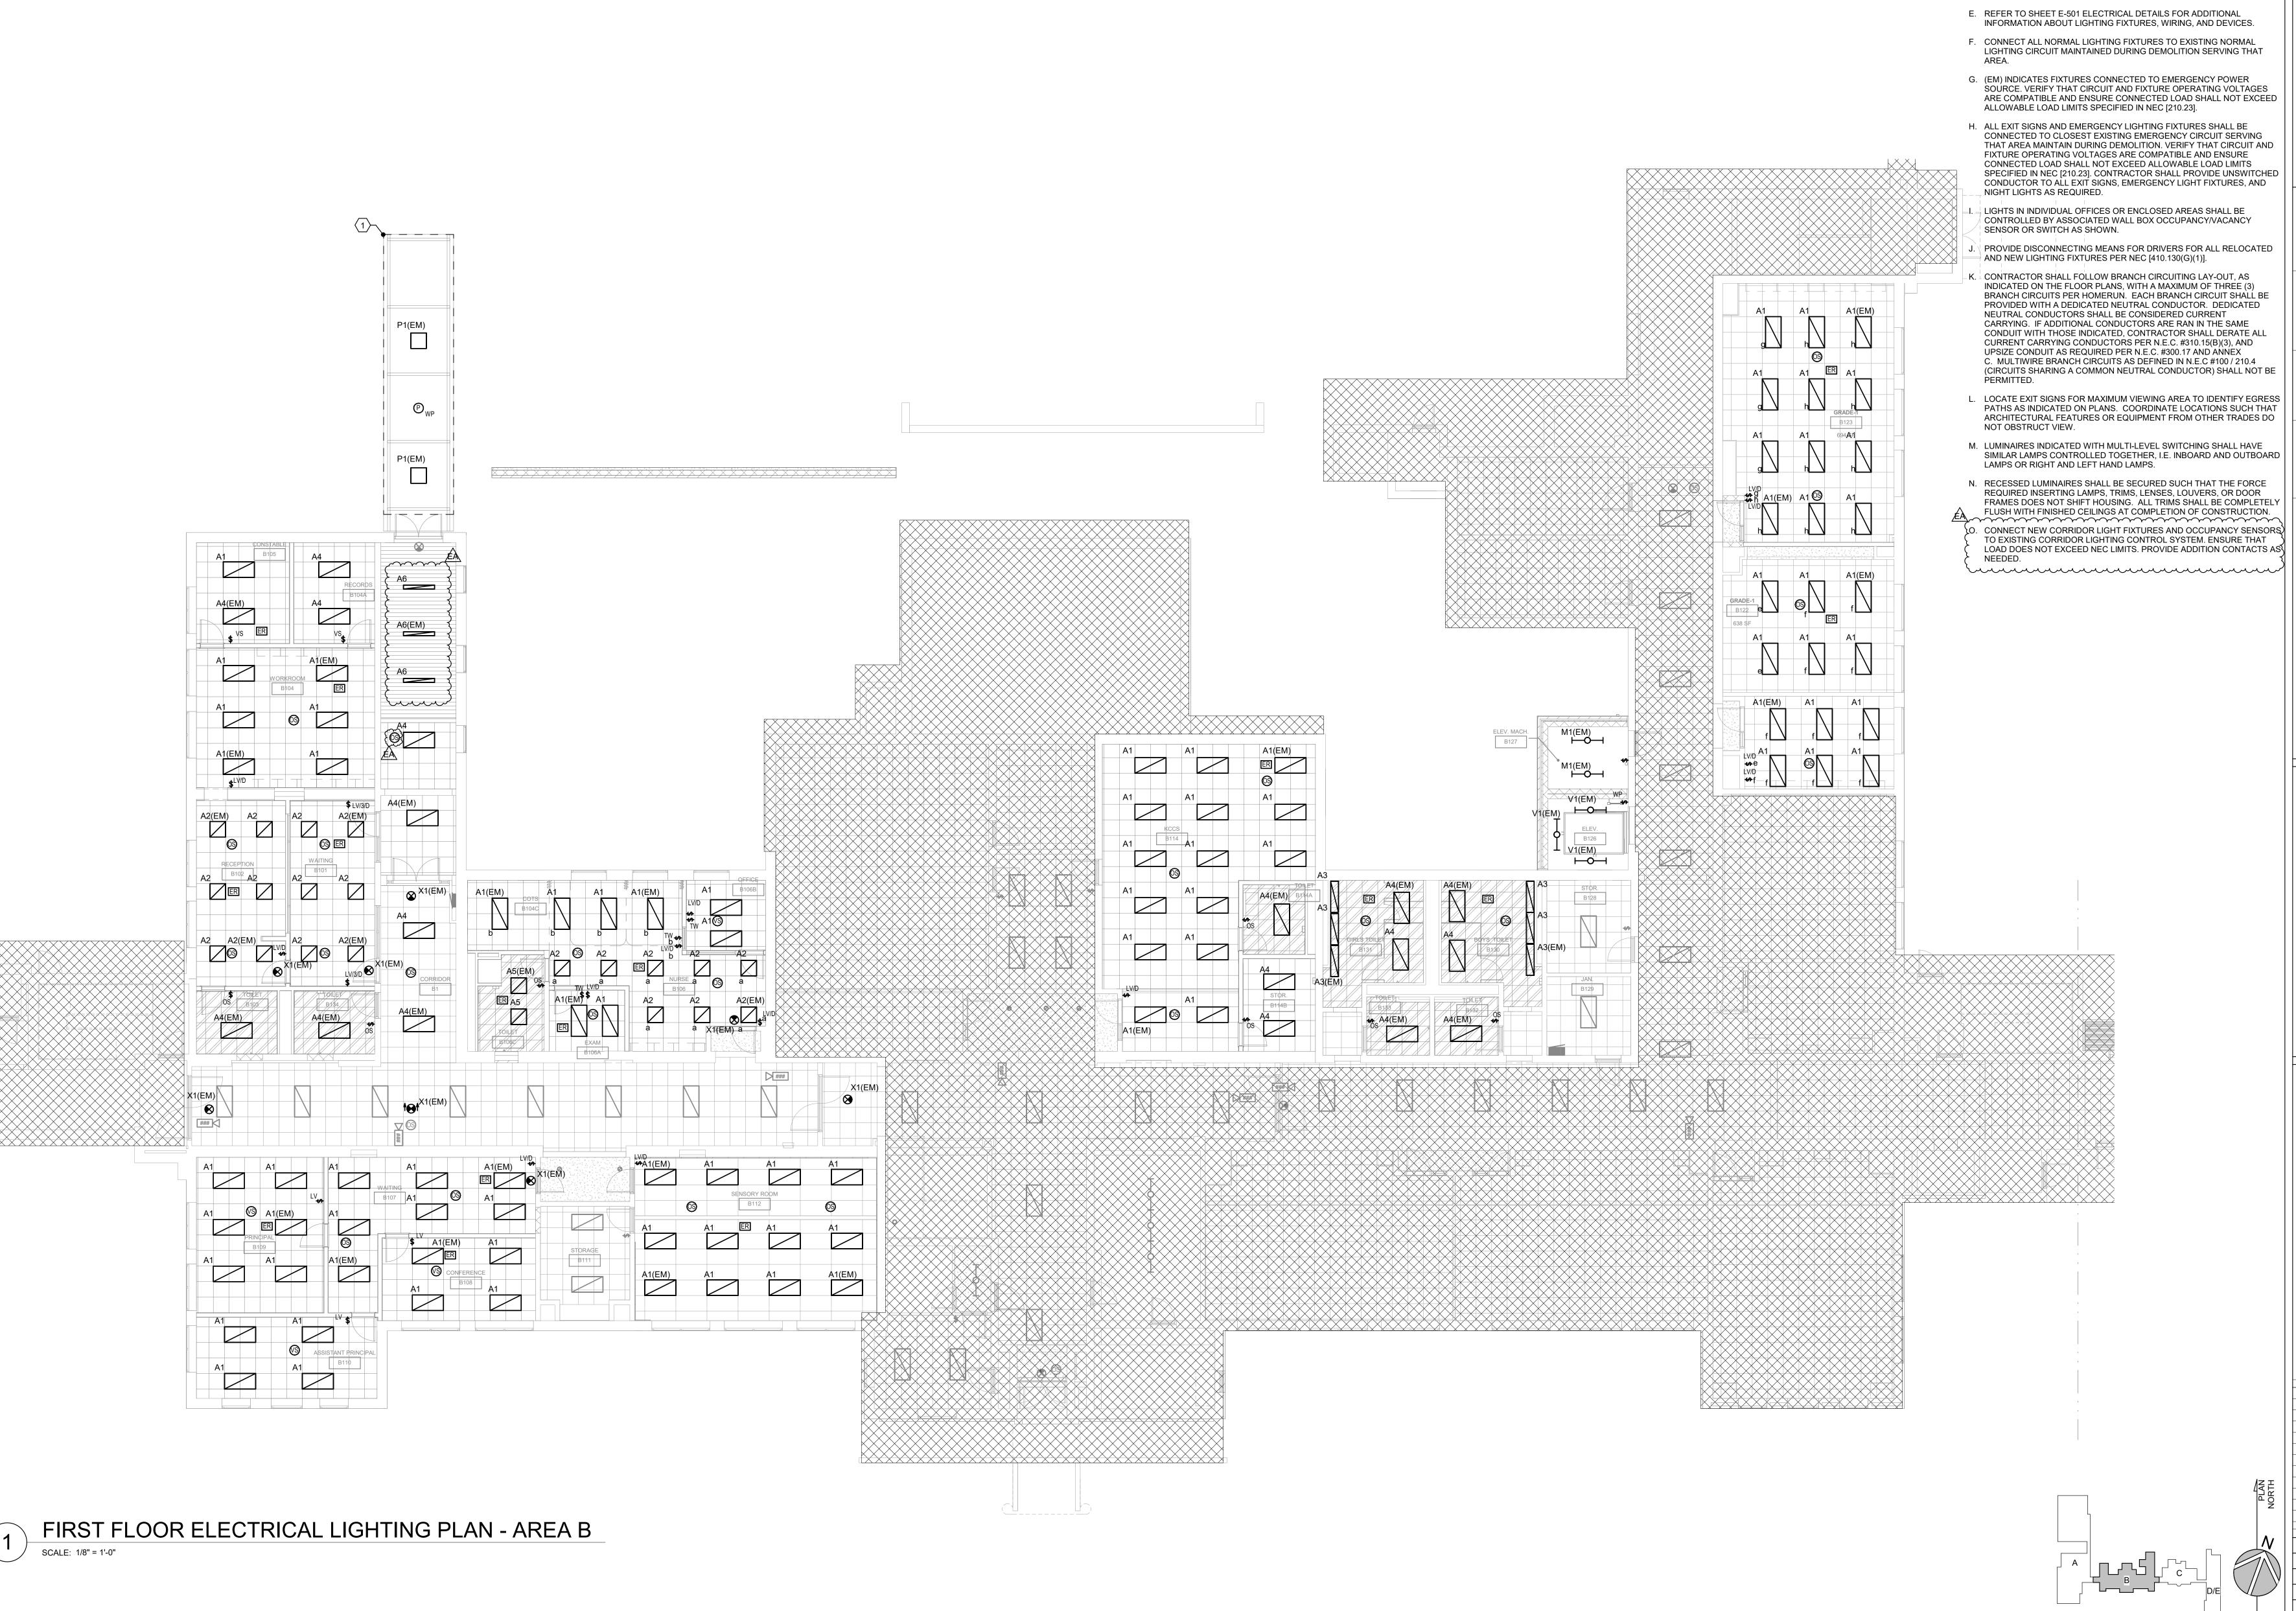

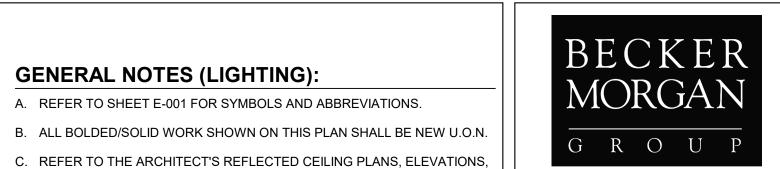

KEY NOTES

PHOTOCELL. PHOTOCELL MANUFACTURER: PACLIGHTS (MODEL #

1 P1(EM) FIXTURES SHALL BE CONTROLLED BY NEW EXTERIOR

SE-PC-SP) OR EQUIVALENT.

GENERAL NOTES (LIGHTING):

CEILING MOUNTED ELECTRICAL DEVICES.

A. REFER TO SHEET E-001 FOR SYMBOLS AND ABBREVIATIONS.

AND CASEWORK DETAILS FOR EXACT LOCATIONS OF ALL WALL AND

D. REFER TO RISER DIAGRAM AND BRANCH CIRCUIT SCHEDULE FOR

FEEDER AND BRANCH CIRCUIT CONDUCTOR SIZES U.O.N.

ARCHITECTURE

ENGINEERING <u>Delaware</u> 309 S Governors Ave

Dover, DE 19904 302.734.7950 The Tower at STAR Campus

Newark, DE 19713 302.369.3700 **Maryland** 312 West Main St, Suite 300 Salisbury, MD 21801 410.546.9100

100 Discovery Boulevard, Suite 102

North Carolina 3333 Jaeckle Drive, Suite 120 Wilmington, NC 28403 910.341.7600

www.beckermorgan.com

CMTA, INC.

FIRE PROTECTION, PLUMBING, MECHANICAL, AND ELECTRICAL ENGINEER 200 WESTGATE CIRCLE, SUITE 404 ANNAPOLIS, MD 21401 410-921-3510

RICHARD Y. JOHNSON & SON, INC. CONSTRUCTION MANAGER

18404 JOHNSON AVENUE LINCOLN, DELAWARE 19960

302-422-3732 fax 302-422-4696

CENTRAL MIDDLE TO **ELEMENTARY** SCHOOL **INTERIOR RENOVATION**


211 DELAWARE AVE DOVER, DE 19901

FIRST FLOOR ELECTRICAL LIGHTING PLAN -AREA B


 EA
 10.07.2024
 ADDENDUM 1

 Mark
 Date
 Descript

E-201B

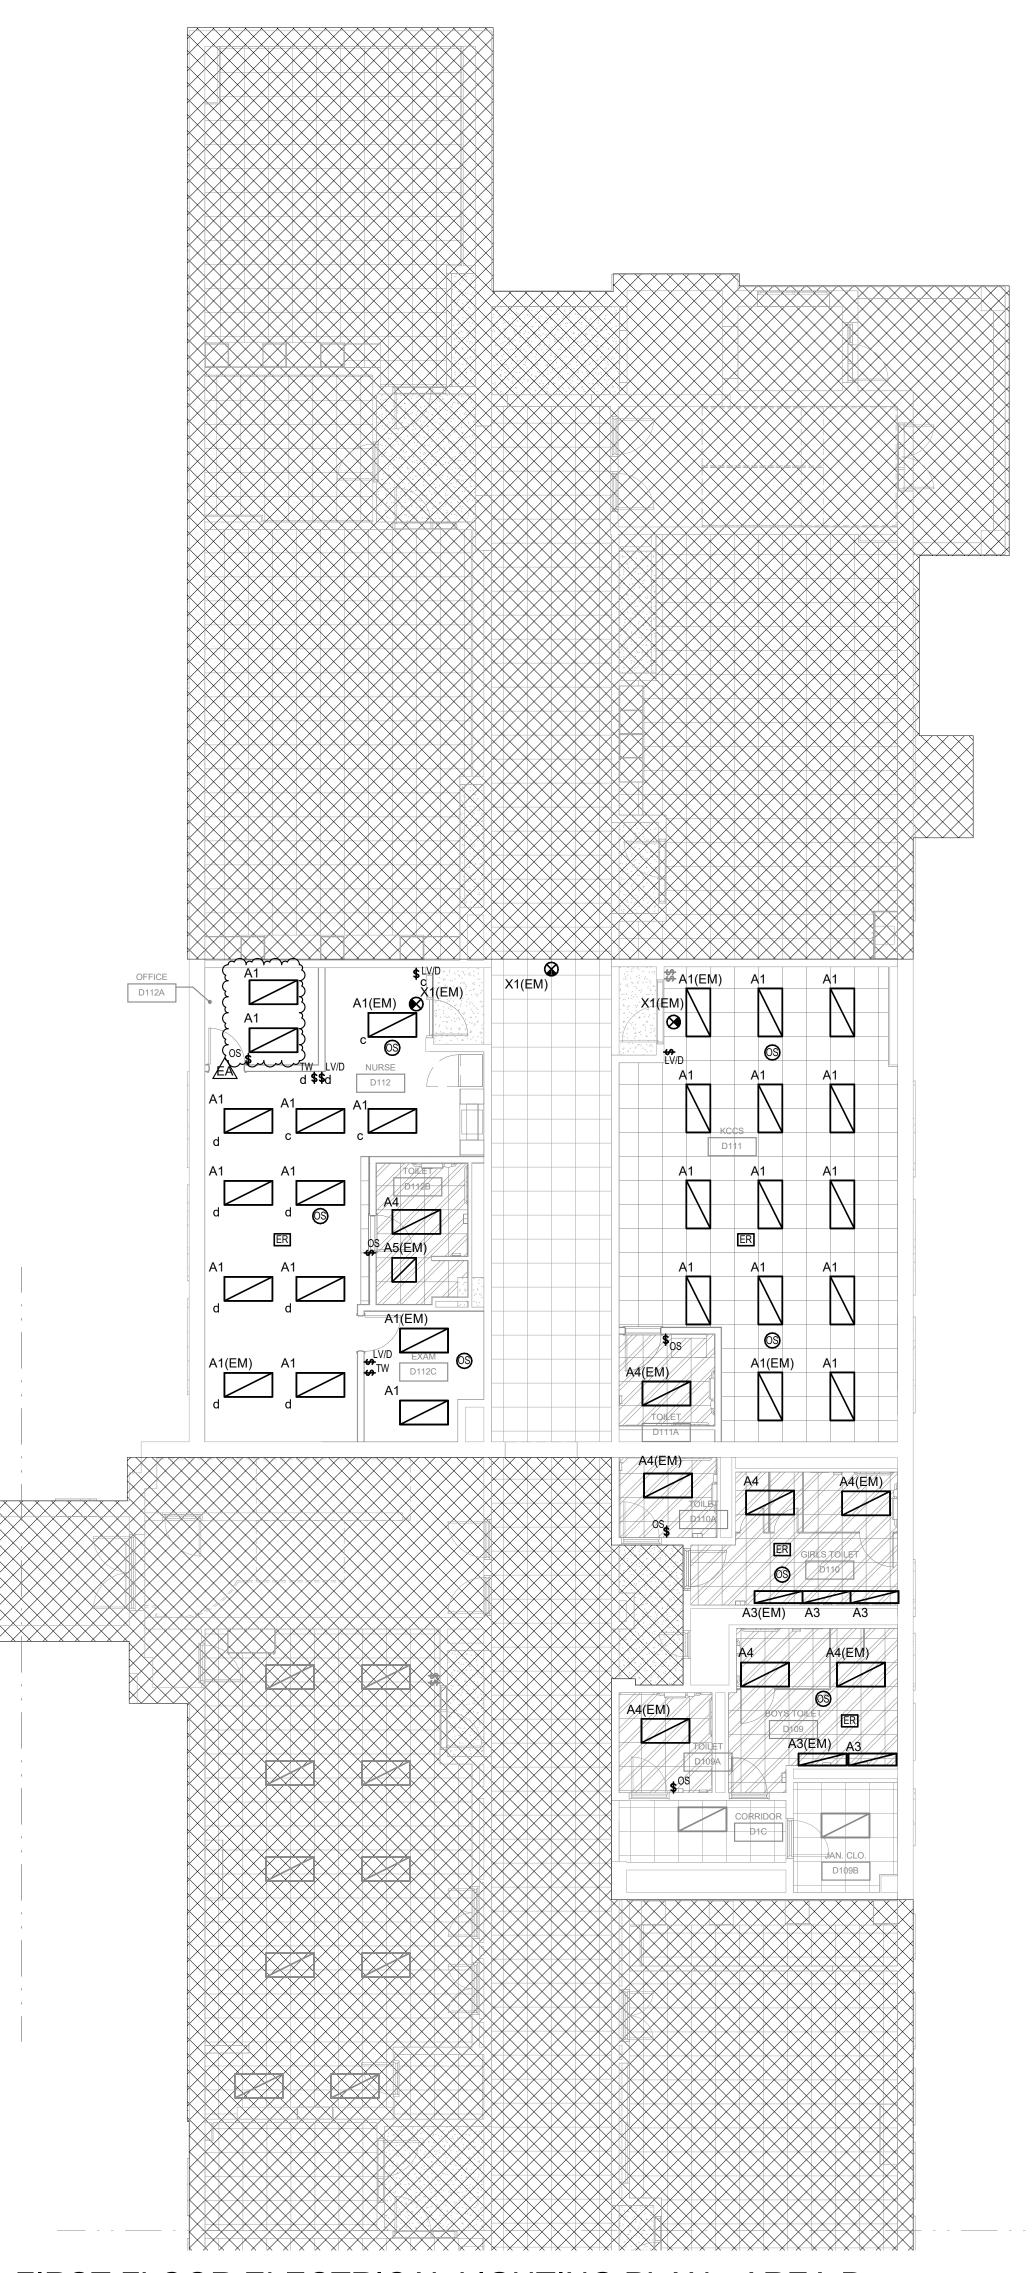

FIRST FLOOR ELECTRICAL LIGHTING PLAN - AREA D SCALE: 1/8" = 1'-0"

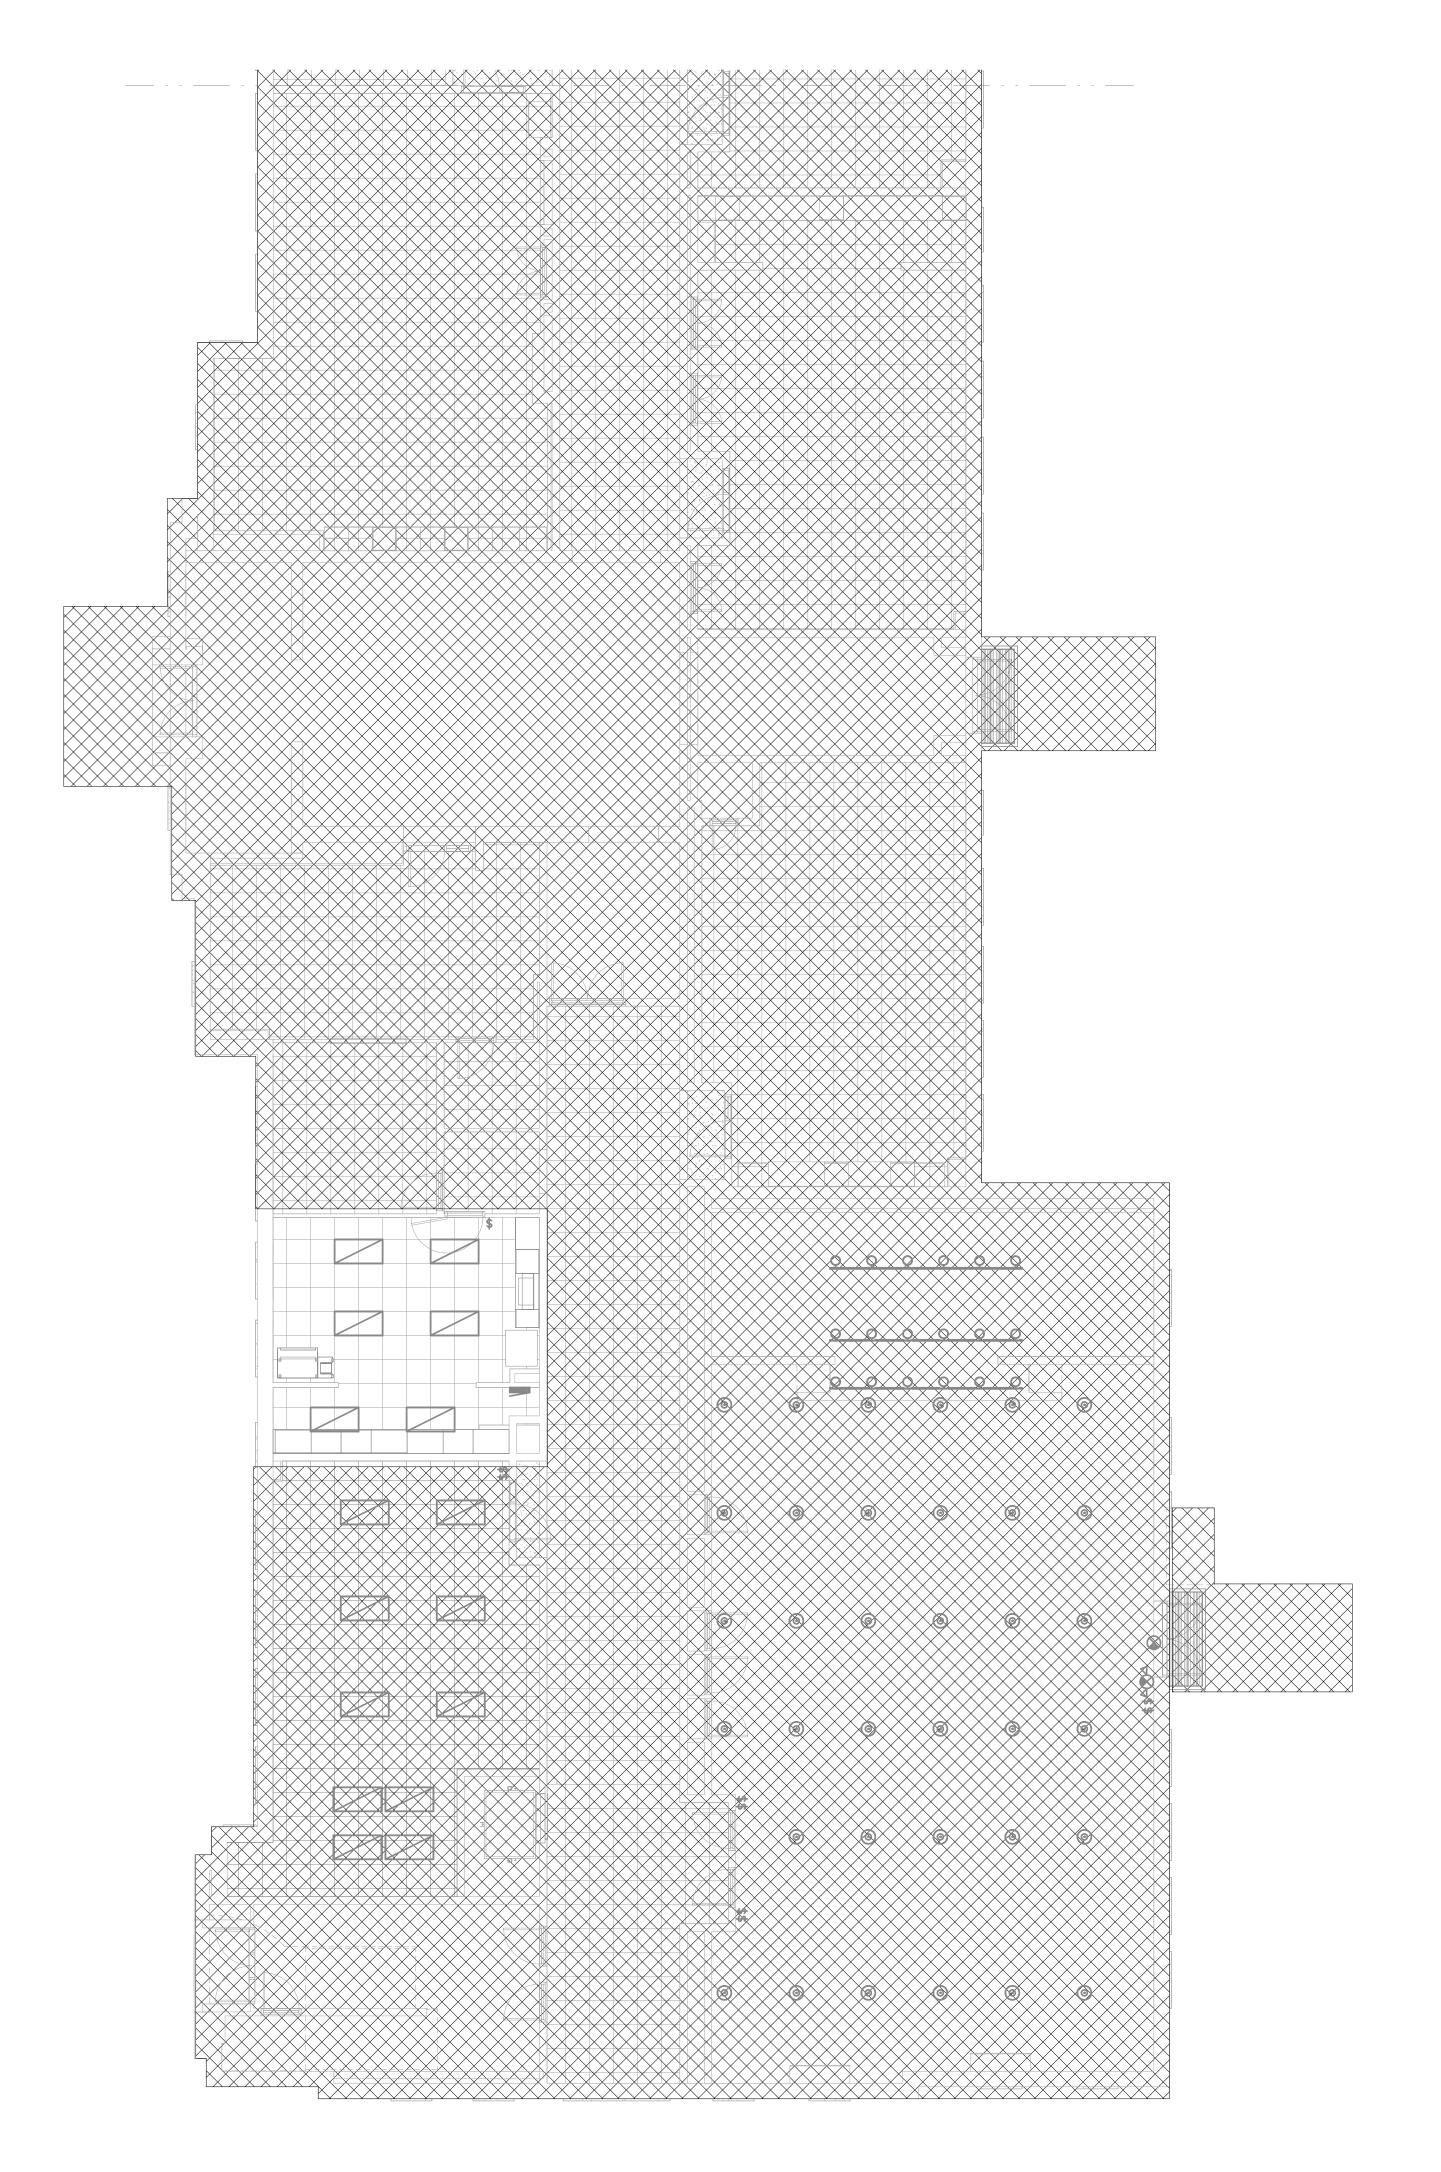

FIRST FLOOR ELECTRICAL LIGHTING PLAN - AREA E

GENERAL NOTES (LIGHTING):

CEILING MOUNTED ELECTRICAL DEVICES.

- A. REFER TO SHEET E-001 FOR SYMBOLS AND ABBREVIATIONS.
- B. ALL BOLDED/SOLID WORK SHOWN ON THIS PLAN SHALL BE NEW U.O.N. C. REFER TO THE ARCHITECT'S REFLECTED CEILING PLANS, ELEVATIONS, AND CASEWORK DETAILS FOR EXACT LOCATIONS OF ALL WALL AND
- D. REFER TO RISER DIAGRAM AND BRANCH CIRCUIT SCHEDULE FOR FEEDER AND BRANCH CIRCUIT CONDUCTOR SIZES U.O.N.
- E. REFER TO SHEET E-501 ELECTRICAL DETAILS FOR ADDITIONAL INFORMATION ABOUT LIGHTING FIXTURES, WIRING, AND DEVICES.
- F. CONNECT ALL NORMAL LIGHTING FIXTURES TO EXISTING NORMAL LIGHTING CIRCUIT MAINTAINED DURING DEMOLITION SERVING THAT

ALLOWABLE LOAD LIMITS SPECIFIED IN NEC [210.23].

- G. (EM) INDICATES FIXTURES CONNECTED TO EMERGENCY POWER SOURCE. VERIFY THAT CIRCUIT AND FIXTURE OPERATING VOLTAGES ARE COMPATIBLE AND ENSURE CONNECTED LOAD SHALL NOT EXCEED
- H. ALL EXIT SIGNS AND EMERGENCY LIGHTING FIXTURES SHALL BE CONNECTED TO CLOSEST EXISTING EMERGENCY CIRCUIT SERVING THAT AREA MAINTAIN DURING DEMOLITION. VERIFY THAT CIRCUIT AND FIXTURE OPERATING VOLTAGES ARE COMPATIBLE AND ENSURE CONNECTED LOAD SHALL NOT EXCEED ALLOWABLE LOAD LIMITS SPECIFIED IN NEC [210.23]. CONTRACTOR SHALL PROVIDE UNSWITCHED CONDUCTOR TO ALL EXIT SIGNS, EMERGENCY LIGHT FIXTURES, AND NIGHT LIGHTS AS REQUIRED.
- I. LIGHTS IN INDIVIDUAL OFFICES OR ENCLOSED AREAS SHALL BE CONTROLLED BY ASSOCIATED WALL BOX OCCUPANCY/VACANCY SENSOR OR SWITCH AS SHOWN.
- J. PROVIDE DISCONNECTING MEANS FOR DRIVERS FOR ALL RELOCATED AND NEW LIGHTING FIXTURES PER NEC [410.130(G)(1)].
- K. CONTRACTOR SHALL FOLLOW BRANCH CIRCUITING LAY-OUT, AS INDICATED ON THE FLOOR PLANS, WITH A MAXIMUM OF THREE (3) BRANCH CIRCUITS PER HOMERUN. EACH BRANCH CIRCUIT SHALL BE PROVIDED WITH A DEDICATED NEUTRAL CONDUCTOR. DEDICATED NEUTRAL CONDUCTORS SHALL BE CONSIDERED CURRENT CARRYING. IF ADDITIONAL CONDUCTORS ARE RAN IN THE SAME CONDUIT WITH THOSE INDICATED, CONTRACTOR SHALL DERATE ALL CURRENT CARRYING CONDUCTORS PER N.E.C. #310.15(B)(3), AND UPSIZE CONDUIT AS REQUIRED PER N.E.C. #300.17 AND ANNEX C. MULTIWIRE BRANCH CIRCUITS AS DEFINED IN N.E.C #100 / 210.4 (CIRCUITS SHARING A COMMON NEUTRAL CONDUCTOR) SHALL NOT BE
- L. LOCATE EXIT SIGNS FOR MAXIMUM VIEWING AREA TO IDENTIFY EGRESS PATHS AS INDICATED ON PLANS. COORDINATE LOCATIONS SUCH THAT ARCHITECTURAL FEATURES OR EQUIPMENT FROM OTHER TRADES DO NOT OBSTRUCT VIEW.
- M. LUMINAIRES INDICATED WITH MULTI-LEVEL SWITCHING SHALL HAVE SIMILAR LAMPS CONTROLLED TOGETHER, I.E. INBOARD AND OUTBOARD LAMPS OR RIGHT AND LEFT HAND LAMPS.
- N. RECESSED LUMINAIRES SHALL BE SECURED SUCH THAT THE FORCE REQUIRED INSERTING LAMPS, TRIMS, LENSES, LOUVERS, OR DOOR FRAMES DOES NOT SHIFT HOUSING. ALL TRIMS SHALL BE COMPLETELY FLUSH WITH FINISHED CEILINGS AT COMPLETION OF CONSTRUCTION.
- O. CONNECT NEW CORRIDOR LIGHT FIXTURES AND OCCUPANCY SENSORS TO EXISTING CORRIDOR LIGHTING CONTROL SYSTEM. ENSURE THAT LOAD DOES NOT EXCEED NEC LIMITS. PROVIDE ADDITION CONTACTS AS



ARCHITECTURE ENGINEERING

<u>Delaware</u> 309 S Governors Ave

Dover, DE 19904 302.734.7950 The Tower at STAR Campus 100 Discovery Boulevard, Suite 102

Newark, DE 19713 302.369.3700 **Maryland** 312 West Main St, Suite 300 Salisbury, MD 21801

410.546.9100 North Carolina 3333 Jaeckle Drive, Suite 120 Wilmington, NC 28403 910.341.7600

www.beckermorgan.com

CMTA, INC.

FIRE PROTECTION, PLUMBING, MECHANICAL, AND ELECTRICAL ENGINEER 200 WESTGATE CIRCLE, SUITE 404 ANNAPOLIS, MD 21401 410-921-3510

RICHARD Y. JOHNSON & SON, INC.

CONSTRUCTION MANAGER 18404 JOHNSON AVENUE LINCOLN, DELAWARE 19960

302-422-3732 fax 302-422-4696

CENTRAL MIDDLE TO

ELEMENTARY SCHOOL INTERIOR **RENOVATION**


211 DELAWARE AVE DOVER, DE 19901

ISSUED

FIRST FLOOR ELECTRICAL LIGHTING PLAN -AREA D/E

EA | 10.07.2024 | ADDENDUM 1 DRAWN BY: JHA PROJ MGR: MO

E-201D/E

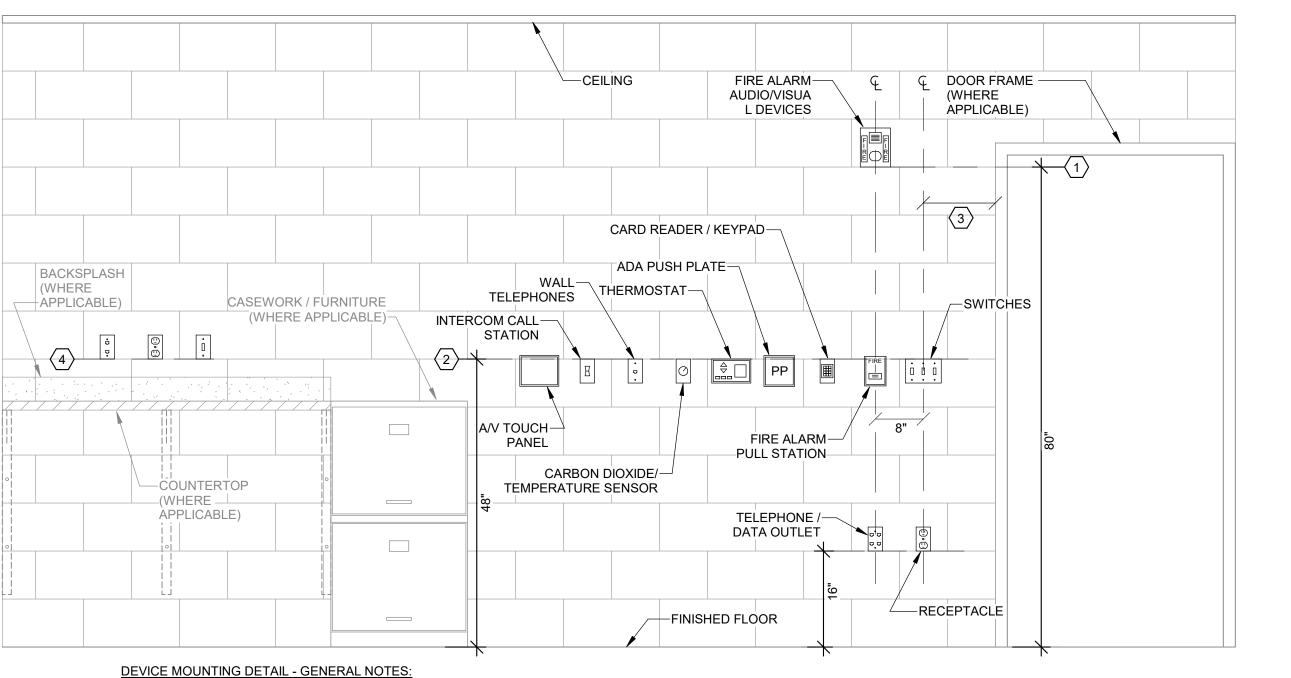

DEVICE MOUNTING DETAIL - GENERAL NOTES

- A. WHERE DEVICES OF ANY DISCIPLINE ARE LOCATED IN THE SAME GENERAL AREA ON THE PLANS AND ARE SHOWN TO BE MOUNTED AT A SIMILAR HEIGHT. ALIGN HORIZONTALLY ALONG TOP OF DEVICE BACKBOX (AS SHOWN IN DETAIL AND DESCRIBED IN KEY NOTE #2).
- B. WHERE DEVICES OF ANY DISCIPLINE ARE LOCATED IN THE SAME GENERAL AREA ON THE PLANS AND ARE SHOWN MOUNTED AT DIFFERENT HEIGHTS, ALIGN VERTICALLY ALONG THE CENTERLINE OF THE DEVICE BACKBOX (AS SHOWN IN DETAIL).
- C. FOR ANY WALL OTHER THAN PAINTED GYPSUM BOARD OR CMU, DEVICE LOCATIONS MUST BE FIELD APPROVED BY ENGINEER OR ARCHITECT PRIOR TO INSTALLATION OF FINISHES.

DEVICE MOUNTING DETAIL - KEY NOTES:

REFER TO FLOOR PLAN FOR NUMBER

OF LOADS. PROVIDE ADDITIONAL

POWER PACKS, ETC AS REQUIRED.

TO ADDITIONAL LOW

VOLTAGE LIGHT

LOCATIONS AS

REQUIRED

SWITCH STATIONS

WIRING SCHEMATIC LEGEND

TYPICAL WALL DEVICE MOUNTING DETAIL

LOAD "A"

LIGHT SWITCH

(LOW VOLTAGE)

LOW-VOLTAGE WIRING BY ELECTRICAL

LINE VOLTAGE WIRING BY ELECTRICAL

CONTRACTOR

SINGLE RELAY DIMMING POWERPACK WITH

RETURNING FROM POWER FAILURE EVENT.

MANUAL ON OPERATION OR AUTO ON OR LATCHING RELAY CONTROL WHEN

- 1. MOUNT VISUAL NOTIFICATION APPLIANCES SO THAT ENTIRE LENS IS BETWEEN 80" AND 96" AFF. IF CEILING IS TOO LOW FOR DEVICE TO BE MOUNTED ABOVE 80", MOUNT SO THAT THE LENS IS WITHIN 6" OF FINISHED CEILING.
- 2. ALIGN BACKBOXES OF DEVICES AT THE MOUNTING HEIGHT INDICATED. MEASURE TO THE TOP OF THE BACKBOX FOR STANDARD OUTLET BOXES. NON-STANDARD BACKBOXES ARE TO BE INSTALLED SUCH THAT THE FINISHED DEVICES ARE ALIGNED ALONG THEIR RESPECTIVE CENTERLINES.
- 3. MOUNTING HEIGHTS SHOWN ILLUSTRATE DESIGN INTENT AND ARE TO BE FOLLOWED UNLESS CONTRADICTED BY APPLICABLE CODE. WHERE DEVICES ARE SHOWN ADJACENT TO DOOR FRAMES ON PLANS INSTALL 12" FROM FRAME TO AVOID SLUSHED SECTIONS OR BRACING, SPECIFIC DEVICES ARE SHOWN IN RELATIVE ORDER FROM DOOR FRAME; WHERE THESE DEVICES ARE NOT PRESENT AT A PARTICULAR LOCATION, ADJUST LOCATIONS CLOSER TO DOOR ACCORDINGLY.
- 4. THE CONTRACTOR IS TO COORDINATE ALL ROUGH-INS WITH ANY COUNTERTOPS/BACKSPLASHES TO AVOID CONFLICT. ALIGN DEVICE BACKBOXES IN THE BOTTOM OF THE NEXT FULL BLOCK ABOVE THE BACKSPLASH AS SHOWN. FOR NON-BLOCK WALLS ALIGN BOTTOM OF DEVICE BACKBOXES 4" ABOVE BACKSPLASH. COORDINATE WORK WITH CASEWORK AND KITCHEN SHOP DRAWINGS ACCORDINGLY. IF CONFLICT STILL ARISES CONTACT THE ENGINEER FOR DIRECTION ON HOW TO PROCEED.

NEUTRAL ←

LIGHTING

RELAY

(NORMAL OR

EMERGENCY)

VACANCY

SENSOR

SENSOR.-

EXTENDED RANGE, DUAL TECHNOLOGY WALL OR CEILING MOUNTED OCCUPANCY

LINE HOT •——

NEUTRAL

LINE HOT

0-10V

CAT 6

REFER TO FLOOR PLAN FOR

CAT 6

CAT 6

CIRCUITING REQUIRED. ROOM MAY

REQUIRE MORE THAN ONE CIRCUIT

2X4 RECESSED LED FIXTURE COLUMBIA LIGHTING LCAT SERIES APPROVED RECESSED 4000K/LED LCAT24-9-40-MW-G-_-ED1-U **EQUIVALENT** A1(EM) 2X4 RECESSED LED FIXTURE - EMERGENCY CIRCUIT CONNECTION COLUMBIA LIGHTING LCAT SERIES APPROVED RECESSED 4000K/LED LCAT24-9-40-MW-G- -ED1-U **EQUIVALENT** 2X2 RECESSED LED FIXTURE COLUMBIA LIGHTING LCAT SERIES APPROVED RECESSED 3500K/LED LCAT22-9-35-LW-G-R-_-ED1-U **EQUIVALENT** APPROVED A2(EM) 2X2 RECESSED LED FIXTURE - EMERGENCY CIRCUIT CONNECTION COLUMBIA LIGHTING LCAT SERIES RECESSED 3500K/LED LCAT22-9-35-LW-G-R- -ED1-U **EQUIVALENT COLUMBIA LIGHTING LCAT SERIES** APPROVED 1X4 RECESSED LED FIXTURE RECESSED 3500K/LED LCAT22-9-35-XW-G-R- -ED-U **EQUIVALENT** A3(EM) 1X4 RECESSED LED FIXTURE - EMERGENCY CIRCUIT CONNECTION COLUMBIA LIGHTING LCAT SERIES APPROVED RECESSED 3500K/LED LCAT22-9-35-XW-G-R- -ED-U **EQUIVALENT COLUMBIA LIGHTING LCAT SERIES** APPROVED A4 2X4 RECESSED LED FIXTURE RECESSED 4000K/LED **EQUIVALENT** LCAT24-9-40-MW-G- -E-U A4(EM) 2X4 RECESSED LED FIXTURE - EMERGENCY CIRCUIT CONNECTION COLUMBIA LIGHTING LCAT SERIES APPROVED RECESSED 4000K/LED 3500 LM **EQUIVALENT** LCAT24-9-40-MW-G- -E-U COLUMBIA LIGHTING LCAT SERIES APPROVED A5 2X2 RECESSED LED FIXTURE RECESSED 3500K/LED 2709 LM LCAT22-9-35-LW-G-R- -E-U **EQUIVALENT** APPROVED A5(EM) 2X2 RECESSED LED FIXTURE - EMERGENCY CIRCUIT CONNECTION COLUMBIA LIGHTING LCAT SERIES RECESSED 3500K/LED A6 .5X4 RECESSED LED FIXTURE COOPER LIGHTING METALUX SERIES APPROVED RECESSED 4000K/LED 4000 LM 4RBG6-100D-L840-90-A3/8-4/18GDIM **EQUIVALENT COOPER LIGHTING METALUX SERIES** APPROVED A6(EM) .5X4 RECESSED LED FIXTURE RECESSED 4000K/LED 4000 LM 4RBG6-100D-ETRD-L840-90-A3/8-4/18GDIM M1(EM) 4' LED STRIP LIGHT FIXTURE COLUMBIA LIGHTING EQUIVALENT APPROVED SURFACE/WALL 3500K/LED 4500 LM 32 120 **EQUIVALENT** MPS-4-35-ML-CP-W-ED-U-MPSWG4 P1(EM) EXTERIOR LED CANOPY LIGHT FIXTURE - EMERGENCY CIRCUIT **PACLIGHTS** APPROVED SURFACE 5000K/LED CONNECTION FCPC-095-50 EQUIVALENT APPROVED V1(EM) 4' VAPORPROOF LED STRIP LIGHT FIXTURE **COLUMBIA LIGHTING** SURFACE/WALL 3500K/LED 5000 LM **EQUIVALENT** CVT4-LSCS X1(EM) EDGE LIT EXIT SIGN - EMERGENCY CIRCUIT CONNECTION LITHONIA EDG/R SERIES APPROVED SURFACE/WALL RED LED EDG- -FACES- RMR-X2 **EQUIVALENT**

LUMINAIRE SCHEDULE

MOUNTING

MANUFACTURERS

BASIS OF DESIGN

GENERAL NOTES (LUMINAIRE SCHEDULE):

DESCRIPTION

- A. ALL LUMINAIRES AND COMPONENTS SHALL BE UL LISTED
- B. WHERE LUMINAIRES ARE SHOWN SPLIT-WIRED (HALF EMERGENCY POWER/ HALF NORMAL POWER) ON FLOOR PLANS, LUMINAIRES SHALL BE PROVIDED WITH MULTIPLE ELECTRONIC BALLASTS FOR MULTIPLE POWER CIRCUITS AS INDICATED ON FLOOR PLANS.
- C. PROVIDE BALLASTS FOR FIXTURE LAMP SWITCHING AS INDICATED ON LIGHTING FLOOR PLANS. WHERE A SINGLE FIXTURE IS POWERED FROM NORMAL AND EMERGENCY POWER, HALF OF THE LAMPS WITH A MINIMUM OF TWO LAMPS SHALL BE ON EMERGENCY POWER.
- D. CONTRACTOR SHALL FOCUS, AIM AND ADJUST LUMINAIRES UNDER THE SUPERVISION AND DIRECTION OF THE ENGINEER AND ARCHITECT. ALLOW LABOR FOR FINAL FOCUS AND ADJUSTMENTS AFTER DARK.
- E. ALL LAY-IN FIXTURES SHALL BE PROVIDED WITH SCREW ON HOLD DOWN CLIPS AND MAXIMUM 6'-0" LONG FLEXIBLE CONDUIT WHIPS.

LIFTS AND SCAFFOLDING SHALL BE AVAILABLE.

TO ADDITIONAL RELAY POWER

INTERFACE DRY CONTACT TO

REFER TO FLOOR PLAN FOR NUMBER

DRAWINGS AS REQUIRED.

OF LOADS. PROVIDE ADDITIONAL

POWER PACKS, ETC AS REQUIRED.

MECHANICAL EQUIPMENT SHOWN ON

PACKS AS REQURIED.

F. EXIT SIGNS AND FIXTURES THAT ARE HATCHED OR WHERE THE FIXTURE TYPE CONTAINS THE SUFFIX "E" FOR EMERGENCY OPERATION SHALL HAVE AN INTEGRAL 90 MINUTE BATTERY INVERTER IF NOT POWERED FROM AN EMERGENCY GENERATOR.

- INTERFACE TO

AUTOMATION

SYSTEM (BAS)

AS REQUIRED.

BUILDING

MINIMUM

LUMENS

LAMPS / CCT

MAXIMUM

WATTAGE

VOLTAGE

REMARKS

Project Information

2018 IECC Energy Code: Central Middle School Project Title: Project Type: Alteration

Construction Site: Owner/Agent: Designer/Contractor: 211 DELAWARE AVENUE DOVER, Delaware 19901

Allowed Interior Lighting Power

A Area Category	B Floor Area (ft2)	C Allowed Watts / ft2	D Allowed Watts	
1-CLASSROOMS & WORKROOMS (Common Space Types:Classroom/Lecture/Training)	5444	0.96	5226	
2-RESTROOMS & TOILETS (Common Space Types:Restrooms)	2954	0.85	2511	
3-OFFICES (Common Space Types:Office - Enclosed)	892	0.93	830	
4-STORAGE (Common Space Types:Storage >=50 - <=1000 sq.ft.)	399	0.46	184	
5-CORRIDOR (Common Space Types:Corridor/Transition >=8 ft wide)	253	0.66	167	
6-LOBBY/RECEPTION/WAITING AREA (Common Space Types:Lobby - General)	854	1.00	854	
7-NURSE/CONFERENCE (Common Space Types:Conference/Meeting/Multipurpose)	1417	1.07	1516	
		Total Allowed Watts =	11287	

Proposed Interior Lighting Power A		С	D	E
Fixture ID : Description / Lamp / Wattage Per Lamp / Ballast	Lamps/ Fixture	# of Fixture		(C X D)
CLASSROOMS & WORKROOMS (Common Space Types: Classroom/Lecture/	Training, 54	44 sq.ft.)		
2X4 LED TROFFER: A1: Other:	1	41	33	1353
2X4 LED TROFFER: A4: Other:	1	48	33	1584
RESTROOMS & TOILETS (Common Space Types: Restrooms, 2954 sq.ft.)				
1X4 LED TROFFER: A3: Other:	1	26	19	494
2X4 LED TROFFER: A4: Other:	1	45	33	1485
2X2 LED TROFFER: A5: Other:	1	3	23	69
OFFICES (Common Space Types: Office - Enclosed, 892 sq.ft.)				
2X4 LED TROFFER: A1: Other:	1	4	33	132
2X4 LED TROFFER: A4: Other:	1	12	33	396
STORAGE (Common Space Types: Storage >=50 - <=1000 sq.ft., 399 sq.ft	.)			
2X4 LED TROFFER: A4: Other:	1	4	33	132
CORRIDOR (Common Space Types: Corridor/Transition >=8 ft wide, 253 sq	.ft.)			
2X4 LED TROFFER: A4: Other:	1	4	33	132
LOBBY/RECEPTION/WAITING AREA (Common Space Types: Lobby - General	854 sq.ft.)			
2X4 LED TROFFER: A4: Other:	1	7	33	231
2X2 LED TROFFER: A5: Other:	1	12	23	276
NURSE/CONFERENCE (Common Space Types: Conference/Meeting/Multipurg	nse 1417 s	a ft)		
2X4 LED TROFFER: A1: Other:	1	18	33	594
	60			

nterior Lighting PASSES Interior Lighting Compliance

Statement

2X2 LED TROFFER: A2: Other

2X4 LED TROFFER: A4: Other

Compliance Statement: The proposed interior lighting alteration project represented in this document is consistent with the building plans, specifications, and other calculations submitted with this permit application. The proposed interior lighting systems have been designed to meet the 2018 IECC requirements in COMcheck Version COMcheckWeb and to comply with any applicable mandatory requirements listed in the Inspection Checklist.

Name - Title Signature

WEATHERPROOF ENCLOSURE FOR 120V PLUG-IN TYPE SUMP PUMP, CONNECTED TO THE STAND-BY EMERGENCY POWER. MOUNT @ 60" ABOVE PIT FLOOR. 4' LINEAR, GASKETED, VAPORPROOF LED LIGHT FIXTURE WITH MOLDED, HIGH-SUMP 1 IMPACT CLEAR ACRYLIC DIFFUSER, PUMP | WP MOUNTED MIN 18" ABOVE PIT FLOOR. ¬∕ PIT ∖ ELEVATOR PIT LIGHTING MUST BE CONNECTED TO LIFE SAFETY EMERGENCY POWER. (TYPICAL OF 3) PROVIDE BOTH HEAT AND SMOKE DETECTORS IN THE ELEVATOR HOISTWAY. WEATHERPROOF GFI RECEPTACLE (CONVENIENCE) CONNECTED TO THE ELEVATOR PIT LIGHTING CIRCUIT. MOUNT @ 36" ABOVE PIT FLOOR. ELEVATOR DOOR (TYPICAL OF 2) ELEVATOR PIT LADDER GFI OUTLET AND LIGHT SWITCH MUST BE CONNECTED SO THAT OPERATION OF ONE DOES NOT AFFECT OPERATION OF THE OTHER. **DETAIL NOTES:**

ALL ELECTRICAL EQUIPMENT LOCATED LESS THAN 4' ABOVE FLOOR SHALL

PROVIDE DUPLEX RECEPTACLE IN

BE WEATHERPROOF (NEMA 4) AND WIRING SHALL BE IDENTIFIED FOR USE IN WET LOCATIONS IN ACCORDANCE WITH THE REQUIREMENTS IN NFPA 70. PIT LIGHTING MUST PROVIDE A MIN. OF 10 FC AT THE PIT FLOOR IN ALL AREAS OF THE PIT. SINGLE CAB ELEVATOR PIT



LIGHTING

RFI AY

(NORMAL OR

EMERGENCY)

OCCUPANCY

SENSOR

ALL POWER PACKS TO BE LOCATED IN CONCEALED LOCATIONS ABOVE ACCESSIBLE CEILINGS. PROVIDE J-HOOKS ON 4' CENTERS ABOVE CEILING FOR ALL CONTROL CABLING INDICATED BETWEEN RELAYS. CONTRACTOR SHALL PROVIDE AN EXTRA 10' OF CONTROL WIRING COILED UP ABOVE CEILING AT OCCUPANCY SENSOR. WHERE MULTIPLE CIRCUITS SERVE ONE AREA, CONTRACTOR SHALL PROVIDE ADDITIONAL RELAY PACKS AS REQUIRED TO CONTROL ALL CIRCUITS IN ROOM TOGETHER. REFER TO

NEUTRAL

LINE HOT

0-10V


LIGHTING

LOAD "B"

- MANUFACTURER'S WIRING DIAGRAMS FOR WIRING REQUIREMENTS. WHERE MULTIPLE SENSORS AND MULTIPLE POWER PACKS ARE REQUIRED IN ONE ROOM, CONTRACTOR SHALL CONNECT SENSORS AND POWER PACKS SUCH THAT MOTION DETECTION BY ANY SENSOR IN THE ROOM SHALL ALLOW ALL CIRCUITS IN THE ROOM TO OPERATE. PROVIDE ALL ACCESSORIES AND WIRE DEVICES PER MANUFACTURER'S REQUIREMENTS FOR OPERATION AS DESCRIBED. SYSTEM SHALL BE SENSOR SWITCH nLIGHT, HUBBELL NX, WATTSTOPPER DLM, OR APPROVED EQUAL. SYSTEM SHALL BE PROVIDED, WIRED AND CONTROLLED AS A COMPLETE
- AND OPERABLE SYSTEM. ALL OCC SENSORS TO BE (CEILING/WALL MOUNTED) DUAL TECHNOLOGY/PIR/ULTRASONIC SENSORS WITH POWER PACKS. FOR SECURE/GOVERNMENT SPACES, COORDINATE VITH OWNER IF DUAL TECHNOLOGY SENSORS ARE ACCEPTABLE OR IF PIR SENSORS ARE REQIURED. WHERE INDICATED AS WALL TYPE, PROVIDE WITH WITH RECESS BACKBOX,
- STUB-OUT AND GROMMETED COVERPLATE FOR CABLING. PROVIDE WITH ADDITIONAL EMS RELAY FOR BUILDING MANAGEMENT.

 CONTRACTOR SHALL SUBMIT SHOP DRAWINGS FOR ALL LIGHTING CONTROLS, SHOWING LOCATIONS OF DEVICES OVERLAID ON RELECTED CEILING PLANS. THESE SHOP DRAWINGS SHALL SHOW ALL WIRING REQUIRED FOR THE SITE SPECIFIC APPLICATION.


IGHTING CONTROL WIRING DIAGRAM

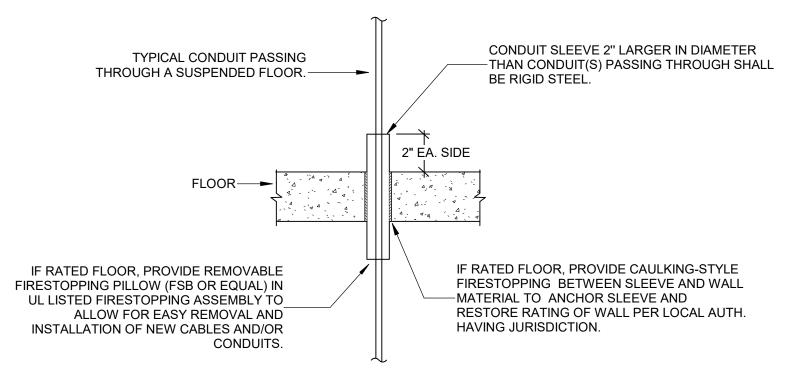

GENERAL FLOOR PENETRATION NOTES A. WHERE CONDUITS PENETRATE A FLOOR SLAB AND ARE EXPOSED, PROVIDE SQUARE 4" HIGH CONCRETEPAD AROUND CONDUIT SLEEVE AND EXTEND SLEEVE 4" ABOVE PAD. B. WHERE CONDUITS OR SLEEVES PENETRATE FLOORS IN GROUPS, THE CONCRETE PAD SHOULD BE

CONTINUOUS AROUND ALL CONDUITS OR SLEEVES. CONDUIT PENETRATION SLEEVE INSTALLATION

NO SCALE

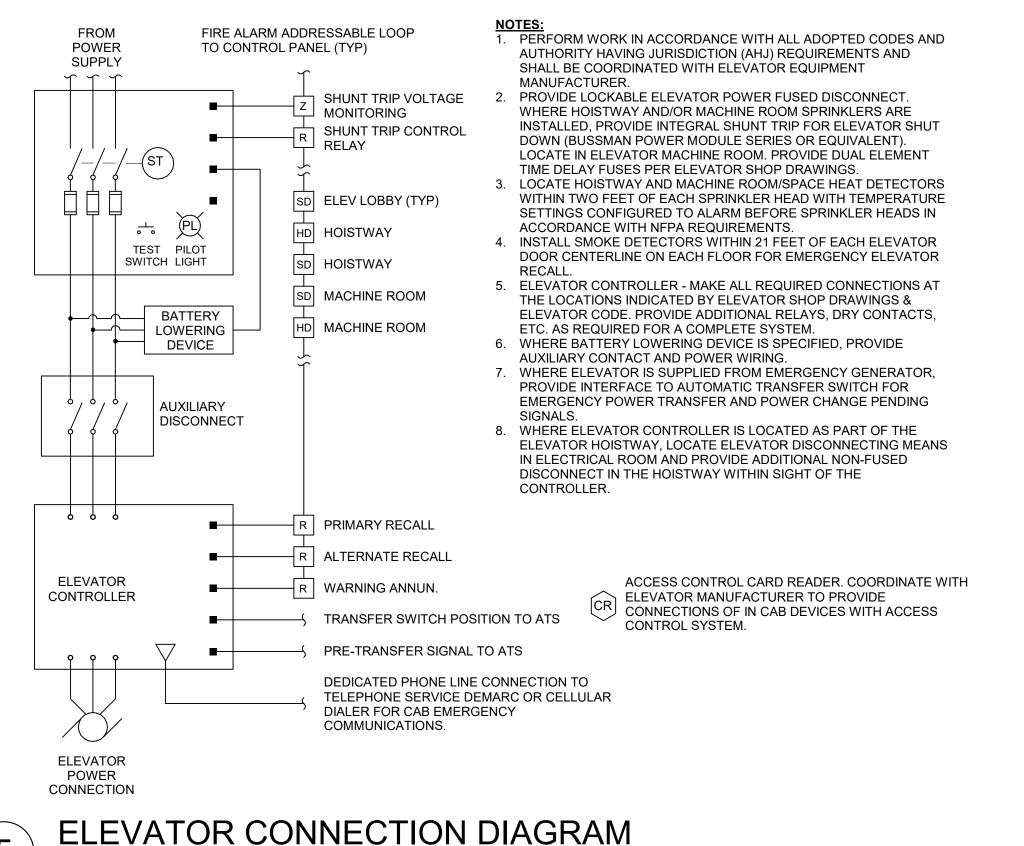

CENTRAL MIDDLE TO **ELEMENTARY SCHOOL INTERIOR** RENOVATION

R O U

ARCHITECTURE

ENGINEERING

<u>Delaware</u>

309 S Governors Ave

Dover, DE 19904

302.734.7950

The Tower at STAR Campus

100 Discovery Boulevard, Suite 102

Newark, DE 19713

302.369.3700

Maryland

312 West Main St, Suite 300

410.546.9100

North Carolina

3333 Jaeckle Drive, Suite 120

Wilmington, NC 28403

910.341.7600

www.beckermorgan.com

MECHANICAL, AND ELECTRICAL ENGINEER

RICHARD Y. JOHNSON & SON, INC

FIRE PROTECTION, PLUMBING,

ANNAPOLIS, MD 21401

CONSTRUCTION MANAGER

18404 JOHNSON AVENUE LINCOLN, DELAWARE 19960

302-422-3732 fax 302-422-4696

200 WESTGATE CIRCLE, SUITE 404

CMTA, INC.

410-921-3510

Salisbury, MD 21801

211 DELAWARE AVE **DOVER, DE 19901**

8 23 184

Total Proposed Watts = 7194

4 33 132

ISSUED FOR BIDDING ISSUED: 09/13/2024


ELECTRICAL DETAILS

ISSUE BLOCK EA 10.07.2024 ADDENDUM 1 PROJECT NO: 2021101.00 DATE: 09.13.2024

E-501

DRAWN BY: JHA PROJ MGR: MO

As indicated

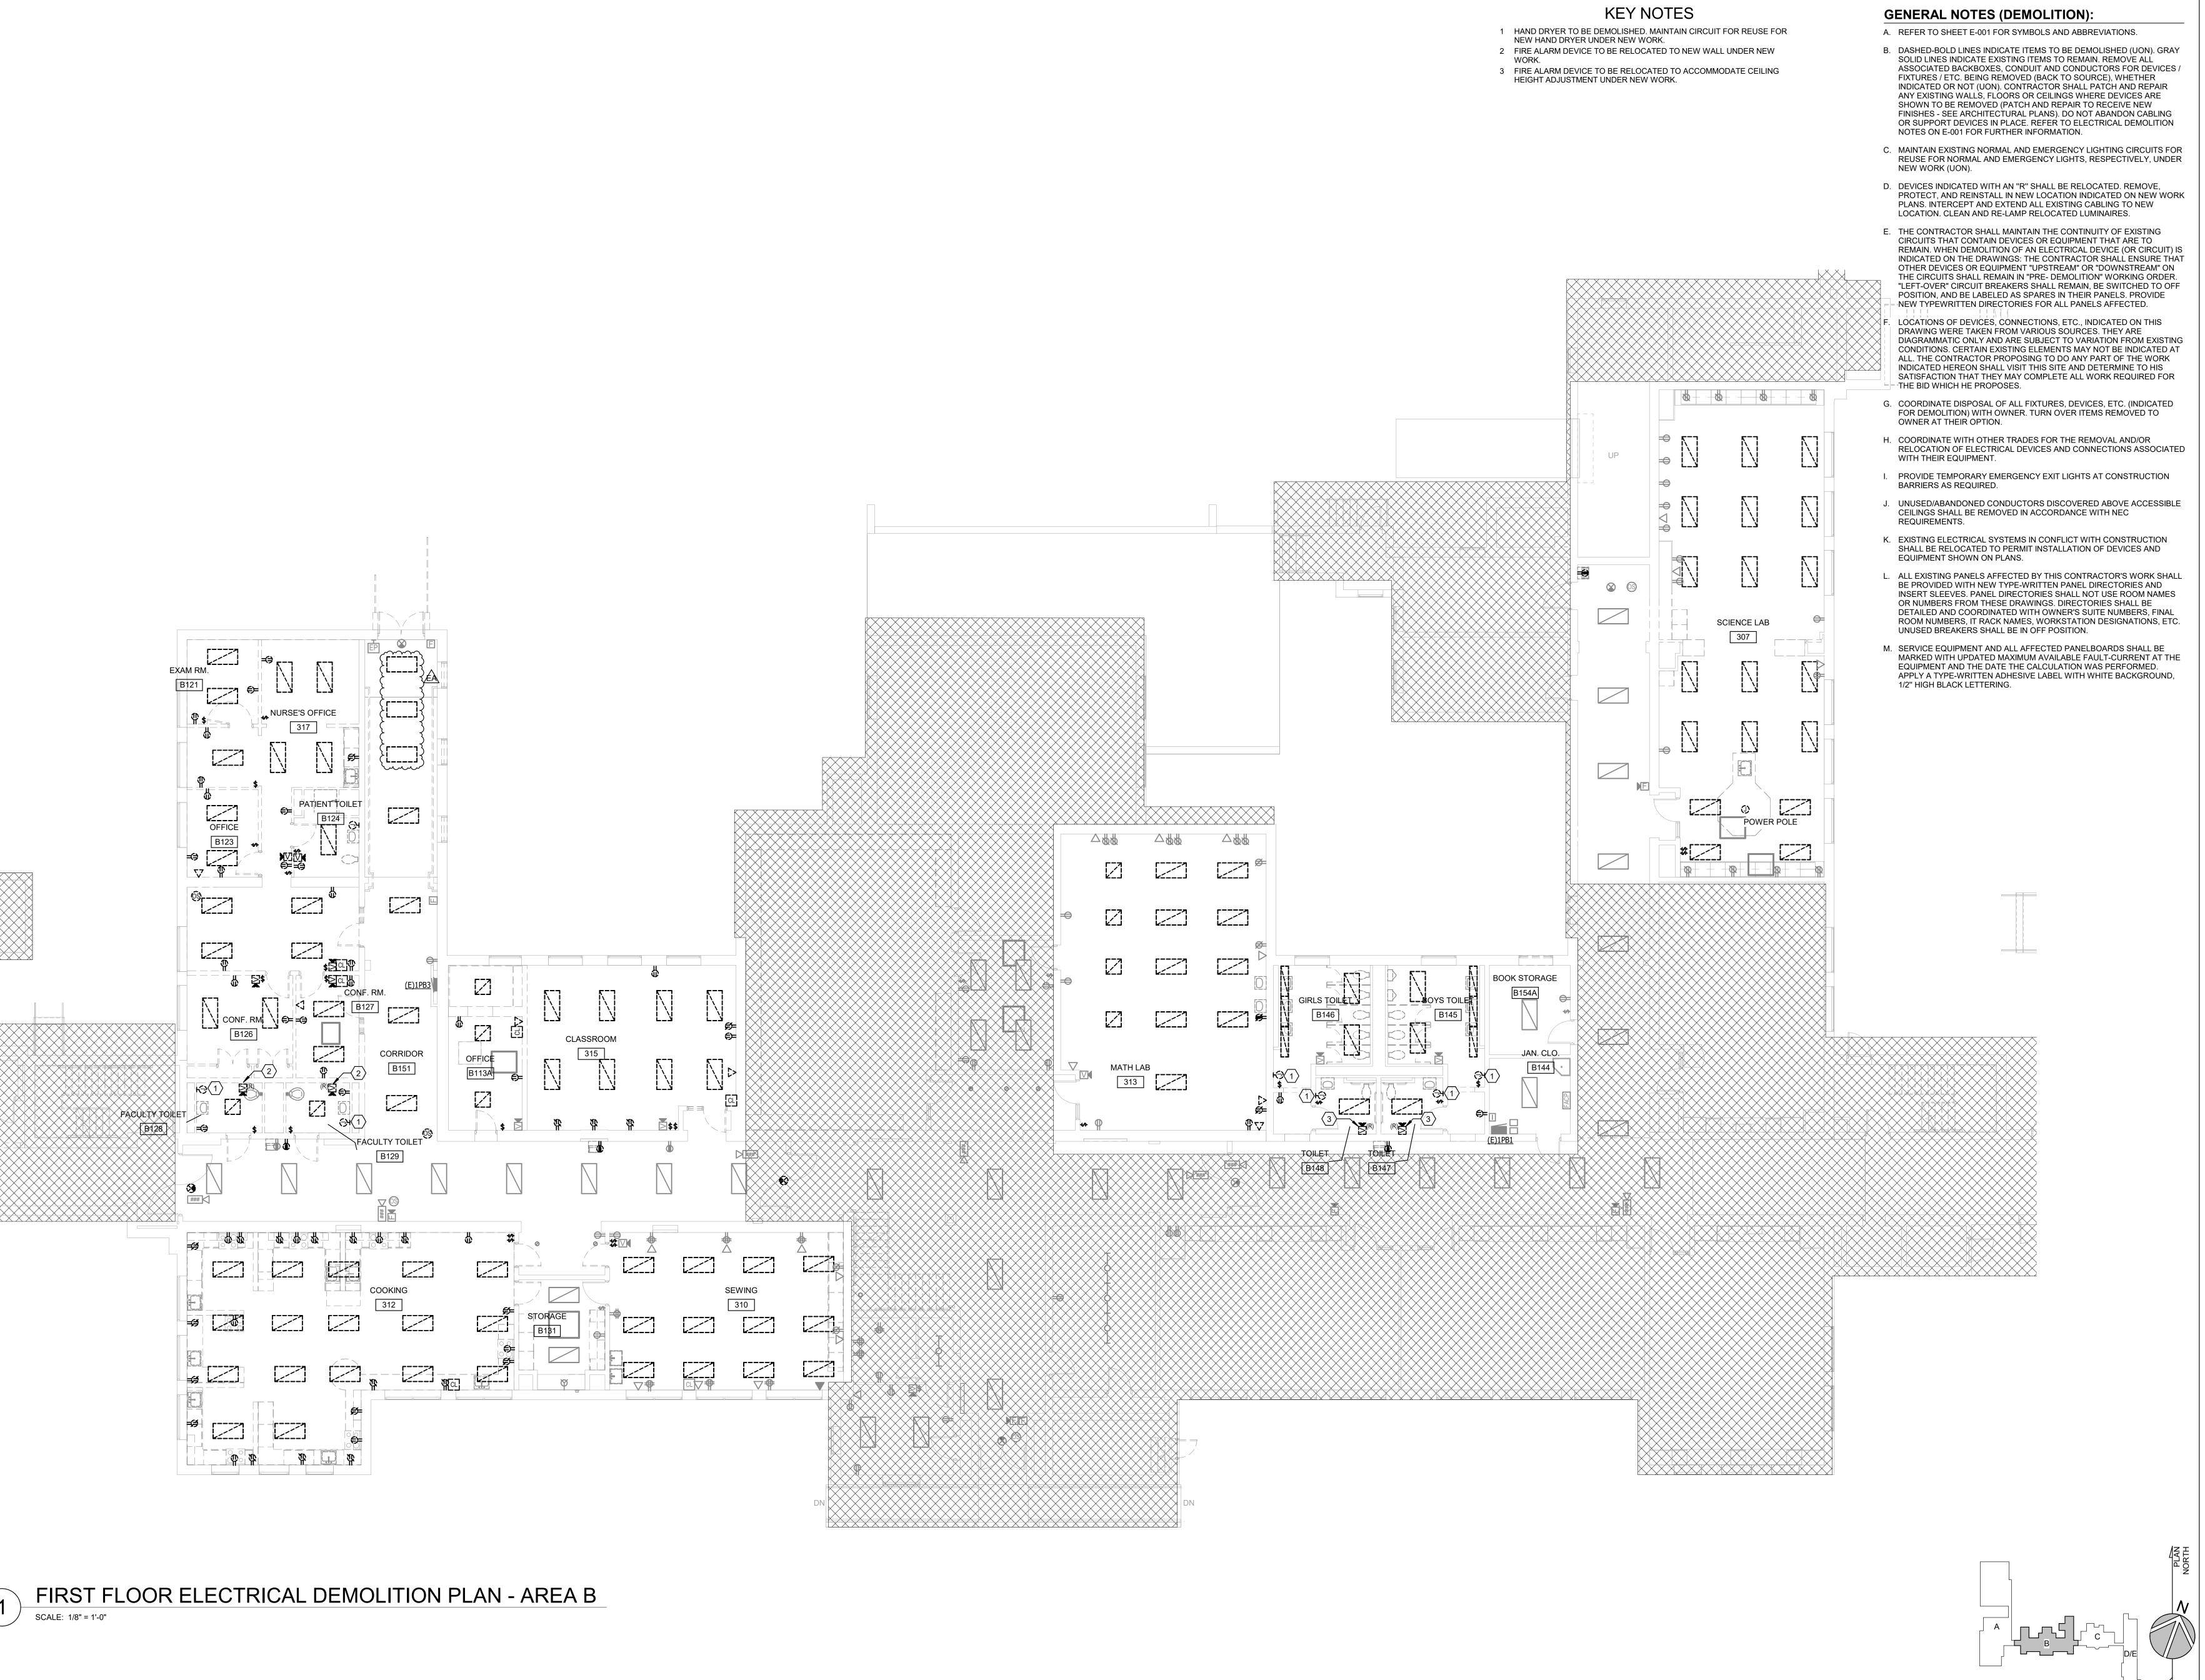

R O U P

ARCHITECTURE ENGINEERING

<u>Delaware</u> 309 S Governors Ave Dover, DE 19904

302.734.7950 The Tower at STAR Campus 100 Discovery Boulevard, Suite 102 Newark, DE 19713 302.369.3700

Maryland 312 West Main St, Suite 300 Salisbury, MD 21801 410.546.9100 North Carolina

3333 Jaeckle Drive, Suite 120 Wilmington, NC 28403 910.341.7600 www.beckermorgan.com

CMTA, INC. FIRE PROTECTION, PLUMBING, MECHANICAL, AND ELECTRICAL ENGINEER 200 WESTGATE CIRCLE, SUITE 404 ANNAPOLIS, MD 21401

410-921-3510 RICHARD Y. JOHNSON & SON, INC. CONSTRUCTION MANAGER

18404 JOHNSON AVENUE LINCOLN, DELAWARE 19960

302-422-3732 fax 302-422-4696

CENTRAL MIDDLE TO ELEMENTARY **SCHOOL INTERIOR RENOVATION**

211 DELAWARE AVE DOVER, DE 19901

ISSUED

FIRST FLOOR ELECTRICAL **DEMOLITION PLAN -**AREA B

 EA
 10.07.2024
 ADDENDUM 1

 Mark
 Date
 Descript

DRAWN BY: JHA PROJ MGR: MO